ROUGE RIVER AOC: JOHNSON CREEK - FISH HATCHERY PARK HABITAT RESTORATION PROJECT





WAYNE COUNTY, MICHIGAN
GLRI EPA AWARD NO. GL-00E02344-0 (DESIGN)
GLRI EPA AWARD NO. GL-00E02478-0 (CONSTRUCTION)
FOR BIDDING - MARCH, 2020





Environmental Consulting & Technology, Inc. 2200 Commonwealth Boulevard, Suite 300 Ann Arbor, Michigan 48105 Phone: 734.769.3004

WITH:

Fax: 734.769.31664










DRAWING INDEX


- 1. COVER SHEET
- 2. EXISTING CONDITIONS
- . SITE PREPARATION
- 4. DEMOLITION PLAN
- 5. DREDGE STAGING AND DEWATERING DETAILS
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- 19. REVEGETATION PLAN JOHNSON CREEK
- 20. REVEGETATION PLAN POND
- 21. DETAILS REVEGETATION

SUPPLEMENTAL INFORMATION

- I. "FIGURE 2 SITE PLAN", OHM SEDIMENT THICKNESS DATA, 2015, FOR INFORMATIONAL PURPOSES ONLY
- 2. "AS-BUILTS", SME, 2019, FOR INFORMATIONAL PURPOSES ONLY
- 3. "NORTHVILLE STATION, MICHIGAN, 1941", HISTORIC PLAN VIEW SKETCH OF FISH HATCHERY PARK

PROJECT DESIGN FUNDED BY THE ENVIRONMENTAL PROTECTION AGENCY THROUGH A GREAT LAKE RESTORATION INITIATIVE GRANT. GLRI EPA AWARD NO. GL-00E02344-0 PROJECT CONSTRUCTION FUNDED BY THE ENVIRONMENTAL PROTECTION AGENCY THROUGH A GREAT LAKE RESTORATION INITIATIVE GRANT. GLRI EPA AWARD NO. GL-00E02478-0

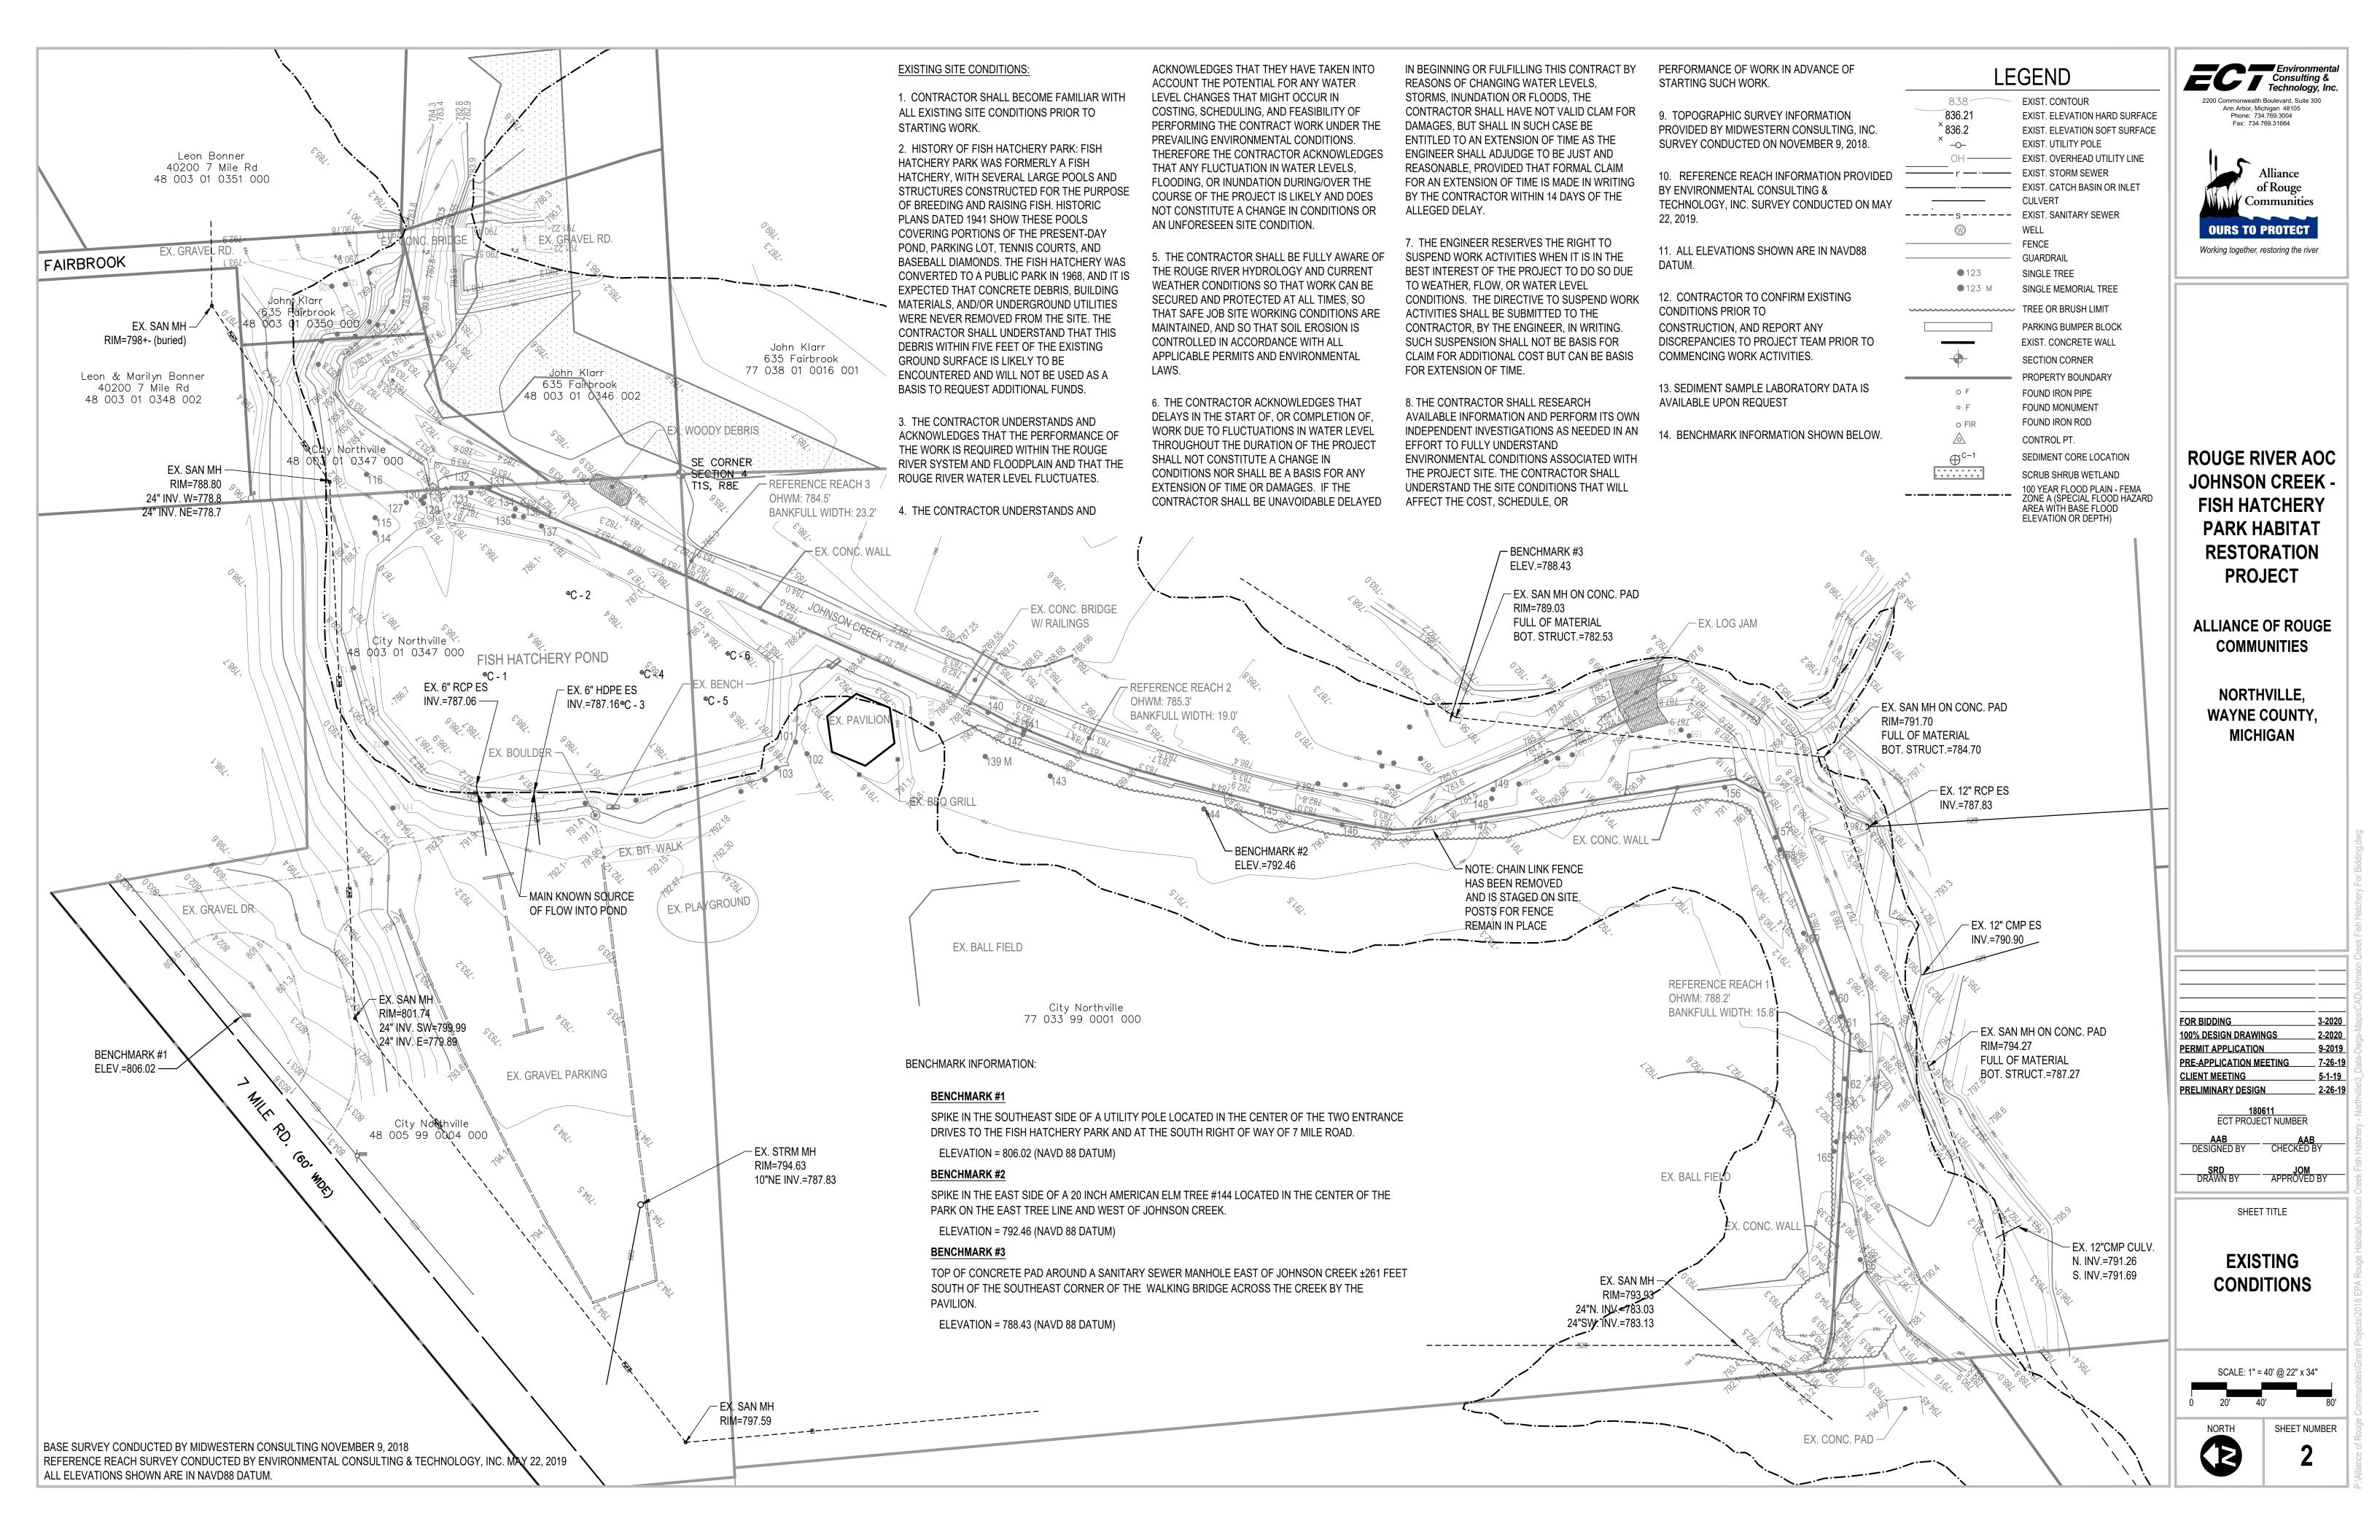

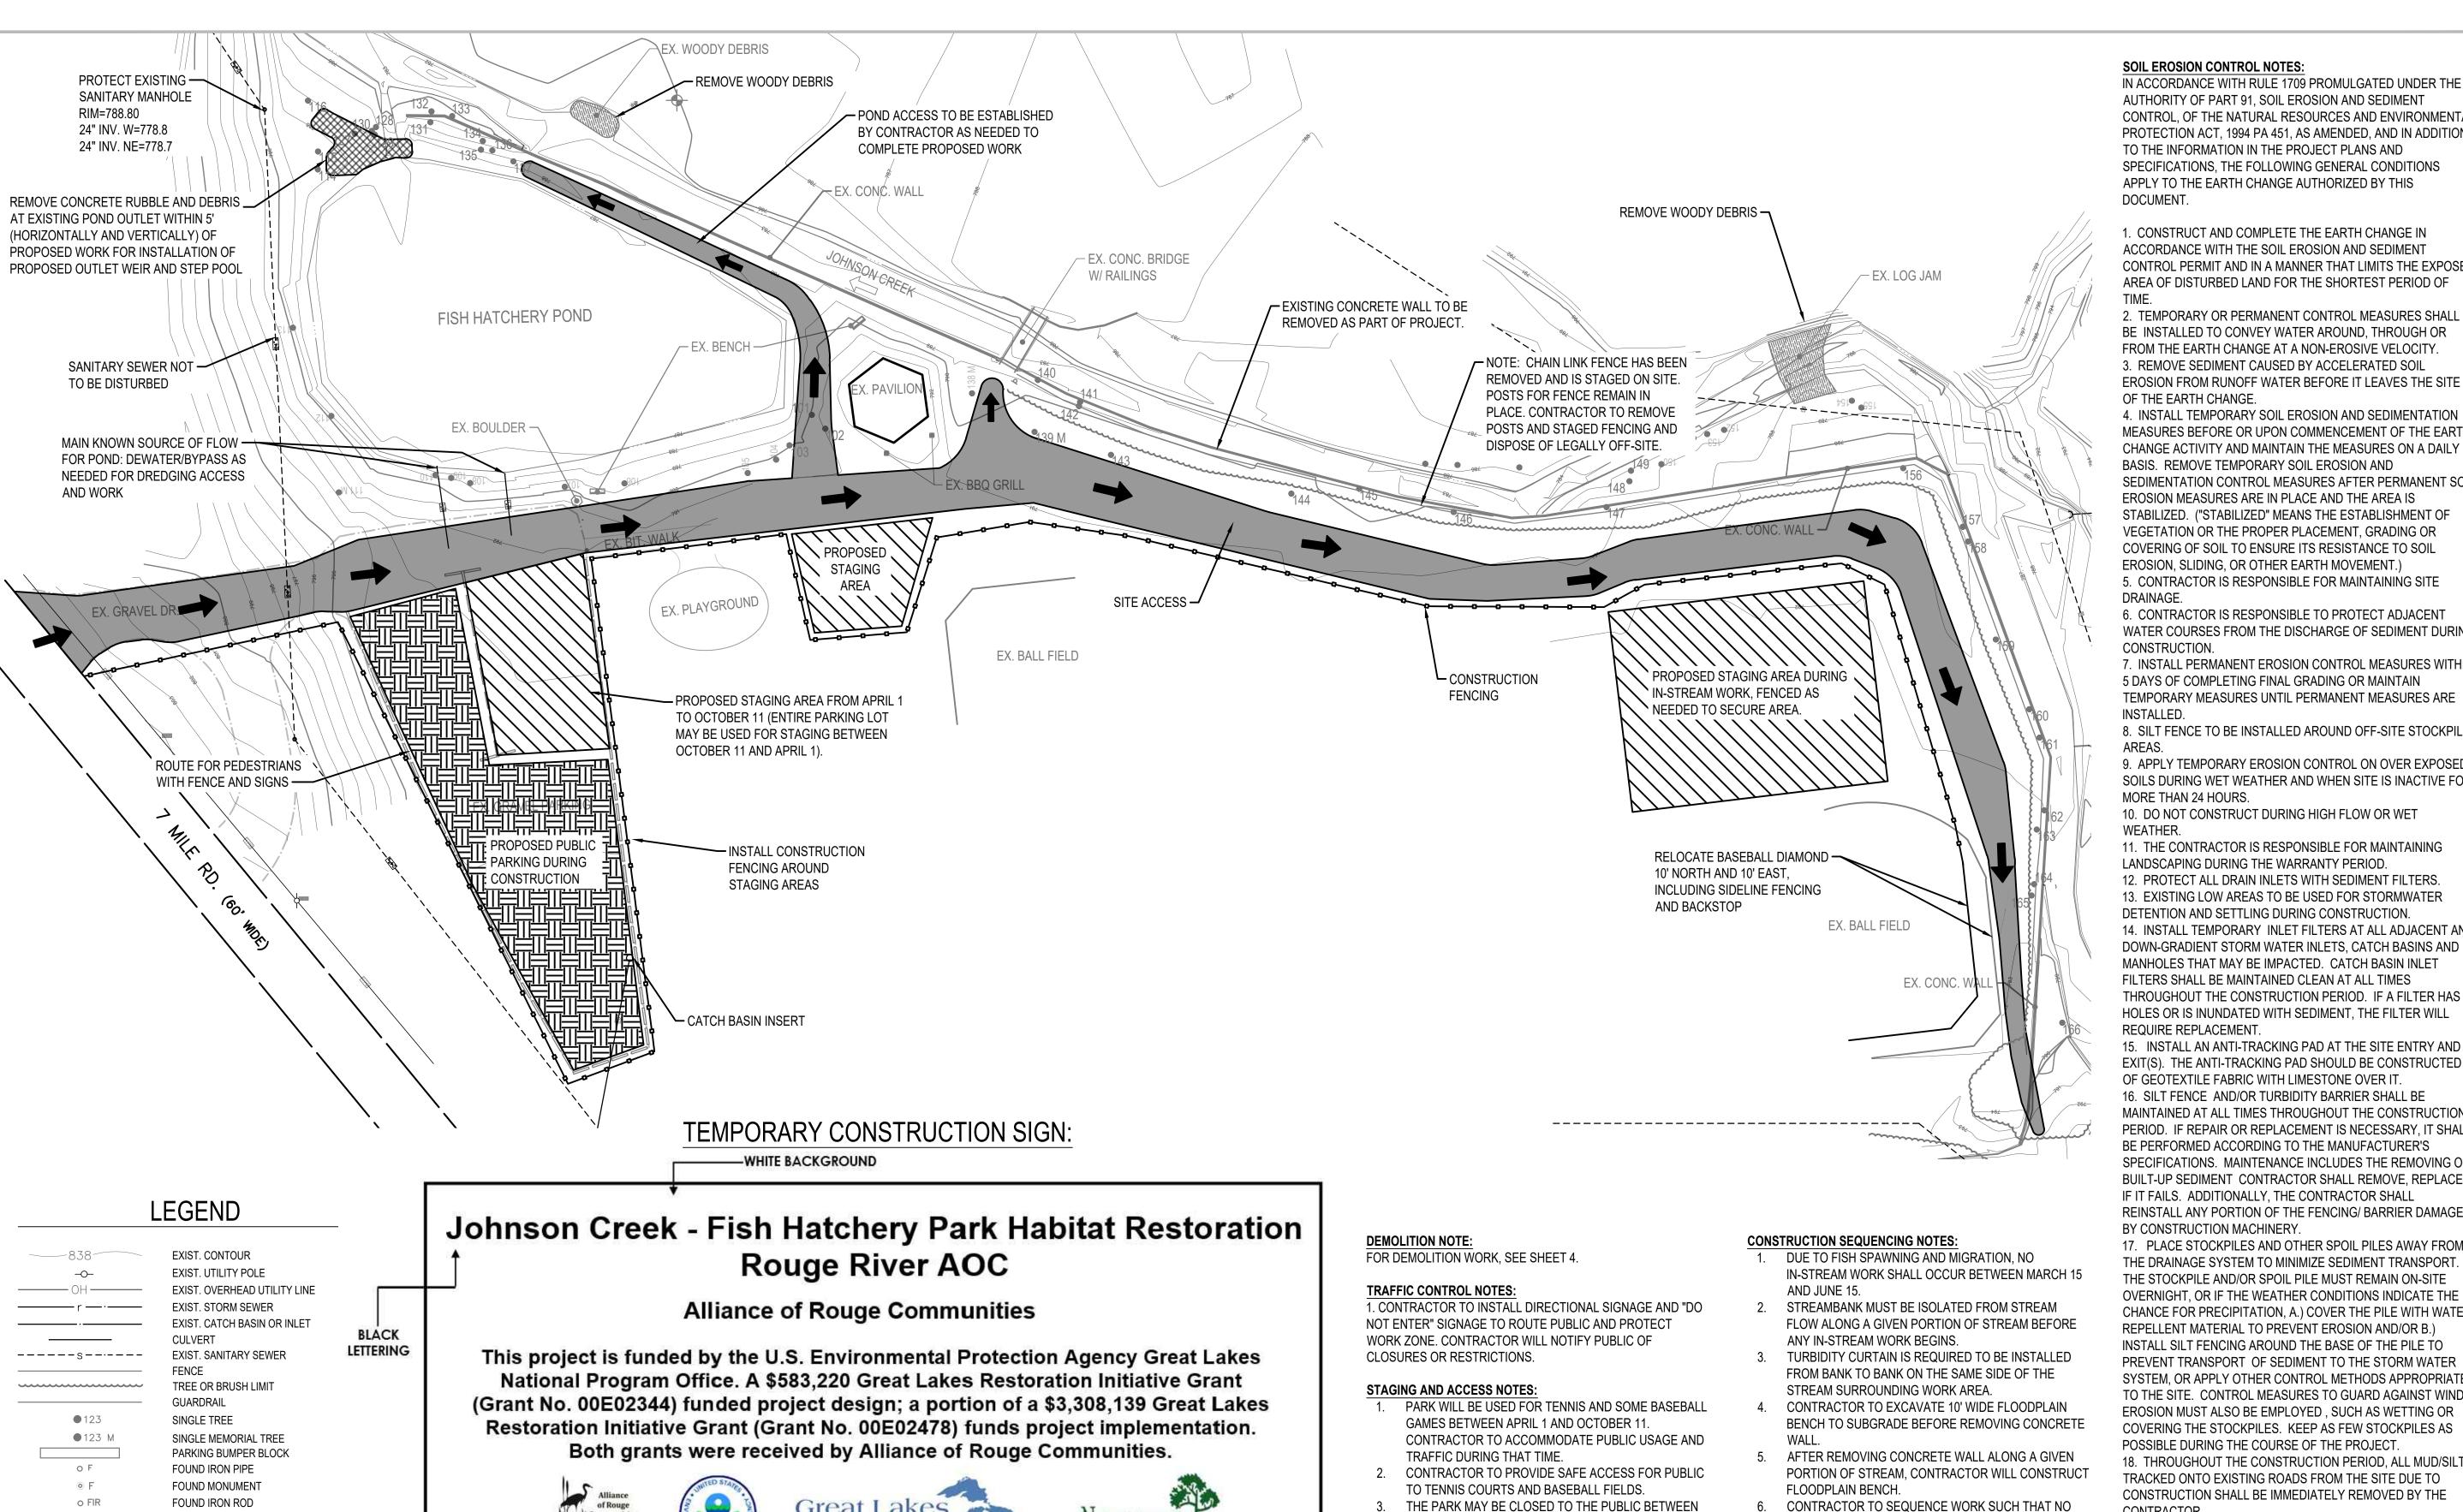

- THE PARK MAY BE CLOSED TO THE PUBLIC BETWEEN OCTOBER 11 AND APRIL 1 AND THE ENTIRE PARKING LOT MAY BE USED FOR STAGING.
- CONTRACTOR TO PROVIDE TRAFFIC SIGNAGE FOR CLOSURES AND PEDESTRIAN/ PUBLIC USE.
- MORE THAN 100 LF OF INCOMPLETE FLOODPLAIN BENCH IS EXPOSED AT ANY TIME. CONTRACTOR TO FINISH STABILIZATION OF FLOODPLAIN BENCH SECTION, INCLUDING SEEDING AND EROSION CONTROL BLANKET INSTALLATION, BEFORE MOVING ON TO NEXT SECTION.

SOIL EROSION CONTROL NOTES:

IN ACCORDANCE WITH RULE 1709 PROMULGATED UNDER THE AUTHORITY OF PART 91, SOIL EROSION AND SEDIMENT CONTROL, OF THE NATURAL RESOURCES AND ENVIRONMENTAL PROTECTION ACT, 1994 PA 451, AS AMENDED, AND IN ADDITION TO THE INFORMATION IN THE PROJECT PLANS AND SPECIFICATIONS, THE FOLLOWING GENERAL CONDITIONS APPLY TO THE EARTH CHANGE AUTHORIZED BY THIS DOCUMENT.

1. CONSTRUCT AND COMPLETE THE EARTH CHANGE IN ACCORDANCE WITH THE SOIL EROSION AND SEDIMENT CONTROL PERMIT AND IN A MANNER THAT LIMITS THE EXPOSED AREA OF DISTURBED LAND FOR THE SHORTEST PERIOD OF

2. TEMPORARY OR PERMANENT CONTROL MEASURES SHALL BE INSTALLED TO CONVEY WATER AROUND, THROUGH OR FROM THE EARTH CHANGE AT A NON-EROSIVE VELOCITY. 3. REMOVE SEDIMENT CAUSED BY ACCELERATED SOIL EROSION FROM RUNOFF WATER BEFORE IT LEAVES THE SITE OF THE EARTH CHANGE.

MEASURES BEFORE OR UPON COMMENCEMENT OF THE EARTH CHANGE ACTIVITY AND MAINTAIN THE MEASURES ON A DAILY BASIS. REMOVE TEMPORARY SOIL EROSION AND SEDIMENTATION CONTROL MEASURES AFTER PERMANENT SOIL EROSION MEASURES ARE IN PLACE AND THE AREA IS STABILIZED. ("STABILIZED" MEANS THE ESTABLISHMENT OF VEGETATION OR THE PROPER PLACEMENT, GRADING OR COVERING OF SOIL TO ENSURE ITS RESISTANCE TO SOIL EROSION, SLIDING, OR OTHER EARTH MOVEMENT.) 5. CONTRACTOR IS RESPONSIBLE FOR MAINTAINING SITE

6. CONTRACTOR IS RESPONSIBLE TO PROTECT ADJACENT WATER COURSES FROM THE DISCHARGE OF SEDIMENT DURING CONSTRUCTION.

7. INSTALL PERMANENT EROSION CONTROL MEASURES WITHIN 5 DAYS OF COMPLETING FINAL GRADING OR MAINTAIN TEMPORARY MEASURES UNTIL PERMANENT MEASURES ARE INSTALLED.

8. SILT FENCE TO BE INSTALLED AROUND OFF-SITE STOCKPILE

9. APPLY TEMPORARY EROSION CONTROL ON OVER EXPOSED SOILS DURING WET WEATHER AND WHEN SITE IS INACTIVE FOR MORE THAN 24 HOURS.

10. DO NOT CONSTRUCT DURING HIGH FLOW OR WET

11. THE CONTRACTOR IS RESPONSIBLE FOR MAINTAINING LANDSCAPING DURING THE WARRANTY PERIOD. 12. PROTECT ALL DRAIN INLETS WITH SEDIMENT FILTERS. 13. EXISTING LOW AREAS TO BE USED FOR STORMWATER DETENTION AND SETTLING DURING CONSTRUCTION. 14. INSTALL TEMPORARY INLET FILTERS AT ALL ADJACENT AND DOWN-GRADIENT STORM WATER INLETS, CATCH BASINS AND MANHOLES THAT MAY BE IMPACTED. CATCH BASIN INLET FILTERS SHALL BE MAINTAINED CLEAN AT ALL TIMES THROUGHOUT THE CONSTRUCTION PERIOD. IF A FILTER HAS HOLES OR IS INUNDATED WITH SEDIMENT, THE FILTER WILL REQUIRE REPLACEMENT

15. INSTALL AN ANTI-TRACKING PAD AT THE SITE ENTRY AND EXIT(S). THE ANTI-TRACKING PAD SHOULD BE CONSTRUCTED OF GEOTEXTILE FABRIC WITH LIMESTONE OVER IT. 16. SILT FENCE AND/OR TURBIDITY BARRIER SHALL BE MAINTAINED AT ALL TIMES THROUGHOUT THE CONSTRUCTION PERIOD. IF REPAIR OR REPLACEMENT IS NECESSARY, IT SHALL BE PERFORMED ACCORDING TO THE MANUFACTURER'S SPECIFICATIONS. MAINTENANCE INCLUDES THE REMOVING OF BUILT-UP SEDIMENT CONTRACTOR SHALL REMOVE, REPLACE IF IT FAILS. ADDITIONALLY, THE CONTRACTOR SHALL REINSTALL ANY PORTION OF THE FENCING/ BARRIER DAMAGED

BY CONSTRUCTION MACHINERY 17. PLACE STOCKPILES AND OTHER SPOIL PILES AWAY FROM THE DRAINAGE SYSTEM TO MINIMIZE SEDIMENT TRANSPORT. IF THE STOCKPILE AND/OR SPOIL PILE MUST REMAIN ON-SITE OVERNIGHT, OR IF THE WEATHER CONDITIONS INDICATE THE CHANCE FOR PRECIPITATION, A.) COVER THE PILE WITH WATER REPELLENT MATERIAL TO PREVENT EROSION AND/OR B.) INSTALL SILT FENCING AROUND THE BASE OF THE PILE TO PREVENT TRANSPORT OF SEDIMENT TO THE STORM WATER SYSTEM, OR APPLY OTHER CONTROL METHODS APPROPRIATE TO THE SITE. CONTROL MEASURES TO GUARD AGAINST WIND EROSION MUST ALSO BE EMPLOYED, SUCH AS WETTING OR COVERING THE STOCKPILES. KEEP AS FEW STOCKPILES AS POSSIBLE DURING THE COURSE OF THE PROJECT. 18. THROUGHOUT THE CONSTRUCTION PERIOD, ALL MUD/SILT

TRACKED ONTO EXISTING ROADS FROM THE SITE DUE TO CONSTRUCTION SHALL BE IMMEDIATELY REMOVED BY THE CONTRACTOR. 19. SEEDING OR OTHER STABILIZATION SHALL BE REQUIRED IMMEDIATELY TO AREAS WHICH HAVE BEEN DAMAGED BY

RUNOFF 20. THE CONTRACTOR SHALL MAINTAIN DUST CONTROL ON THE SITE THROUGHOUT THE DURATION OF THE CONSTRUCTION PROCESS.

00 Commonwealth Boulevard, Suite 300 Ann Arbor, Michigan 48105 Phone: 734.769.3004 Fax: 734.769.31664 of Rouge Communities **OURS TO PROTECT** Working together, restoring the river

> ROUGE RIVER AOC **JOHNSON CREEK FISH HATCHERY PARK HABITAT RESTORATION PROJECT**


ALLIANCE OF ROUGE COMMUNITIES

NORTHVILLE. WAYNE COUNTY, MICHIGAN

FOR BIDDING 100% DESIGN DRAWINGS 2-2020 PERMIT APPLICATION <u>9-2019</u> PRE-APPLICATION MEETING <u>7-26-19</u> CLIENT MEETING <u>5-1-19</u> PRELIMINARY DESIGN <u>2-26-19</u> 180611 ECT PROJECT NUMBER

SHEET TITLE

SITE **PREPARATION**

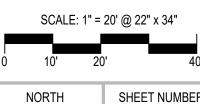

SIGN DIMENSIONS: 1200 mm x 2400 mm x 19 mm (approx. 4' x 8' x 3/4") PLYWOOD PANEL (APA RATED A-B GRADE-EXTERIOR)

RESTORATION

Contractor: (Insert Logo Here)

100 YEAR FLOOD PLAIN - FEMA ZONE

(SPECIAL FLOOD HAZARD AREA WITH

BASE FLOOD ELEVATION OR DEPTH)

PROPOSED PUBLIC ACCESS/PARKING

PROPOSED CONCRETE RUBBLE REMOVAL


PROPOSED STAGING AREA

PROPOSED ACCESS ROUTE

CONSTRUCTION FENCING

1

-0---0---0---

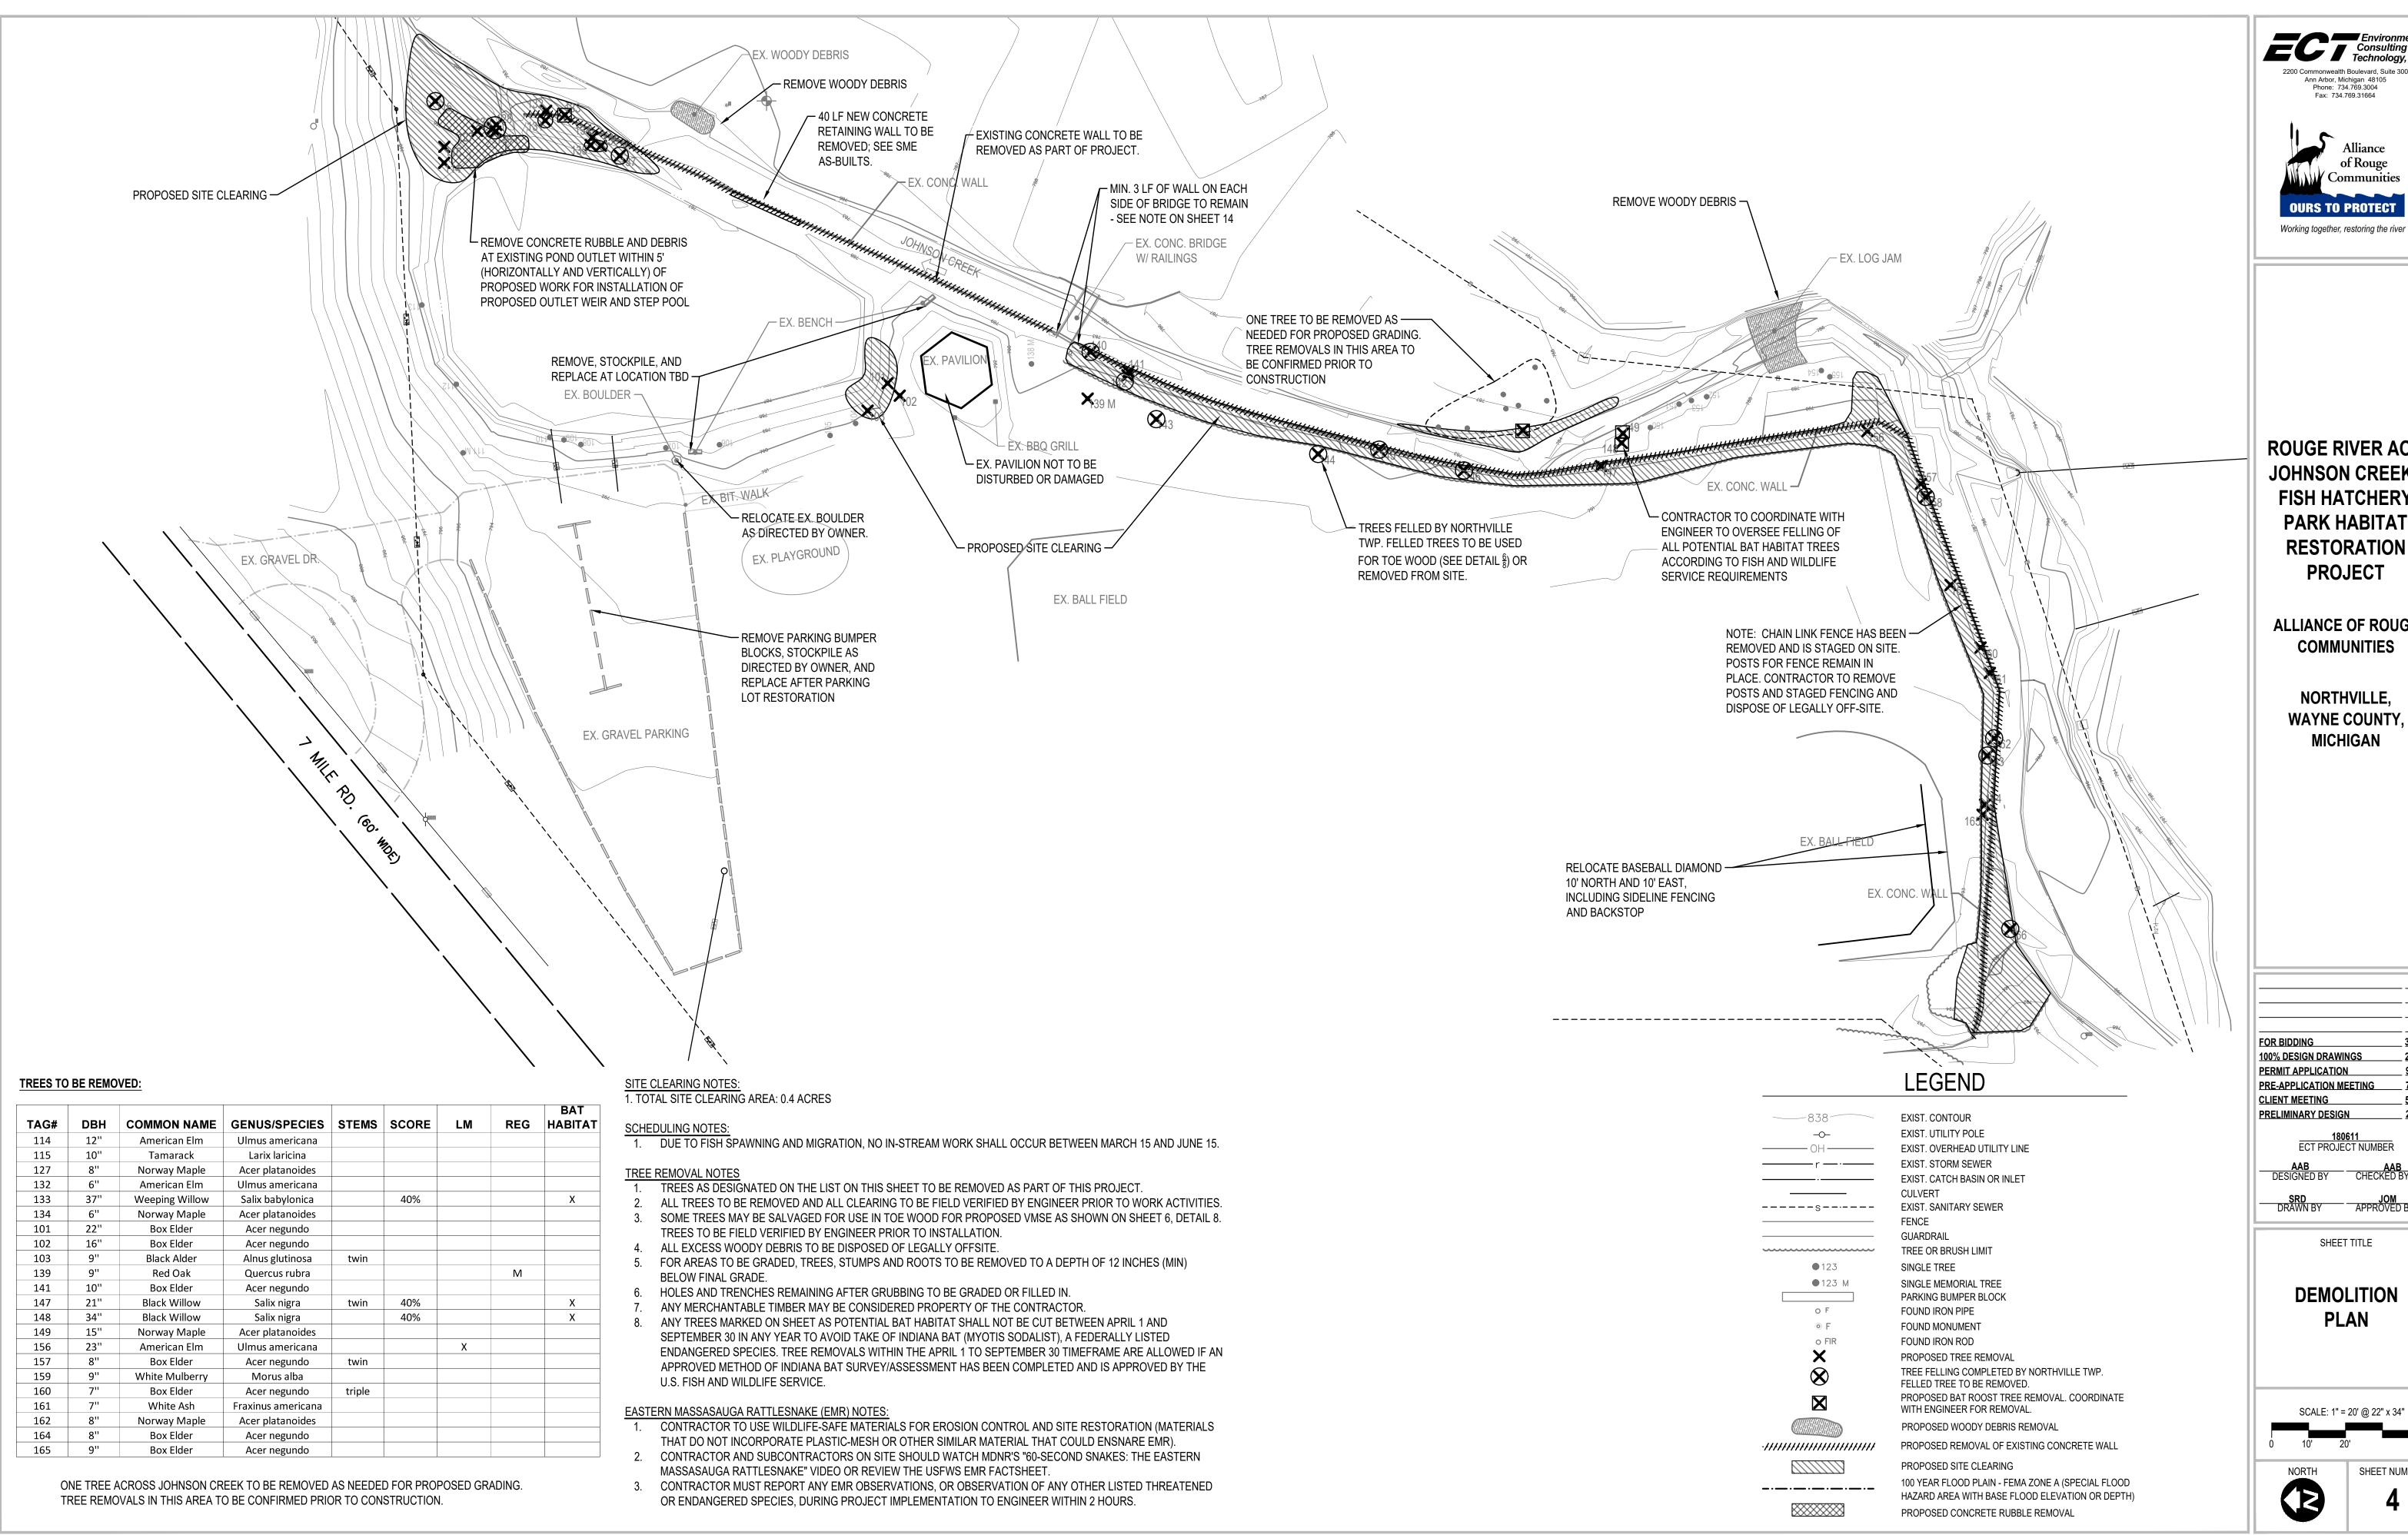

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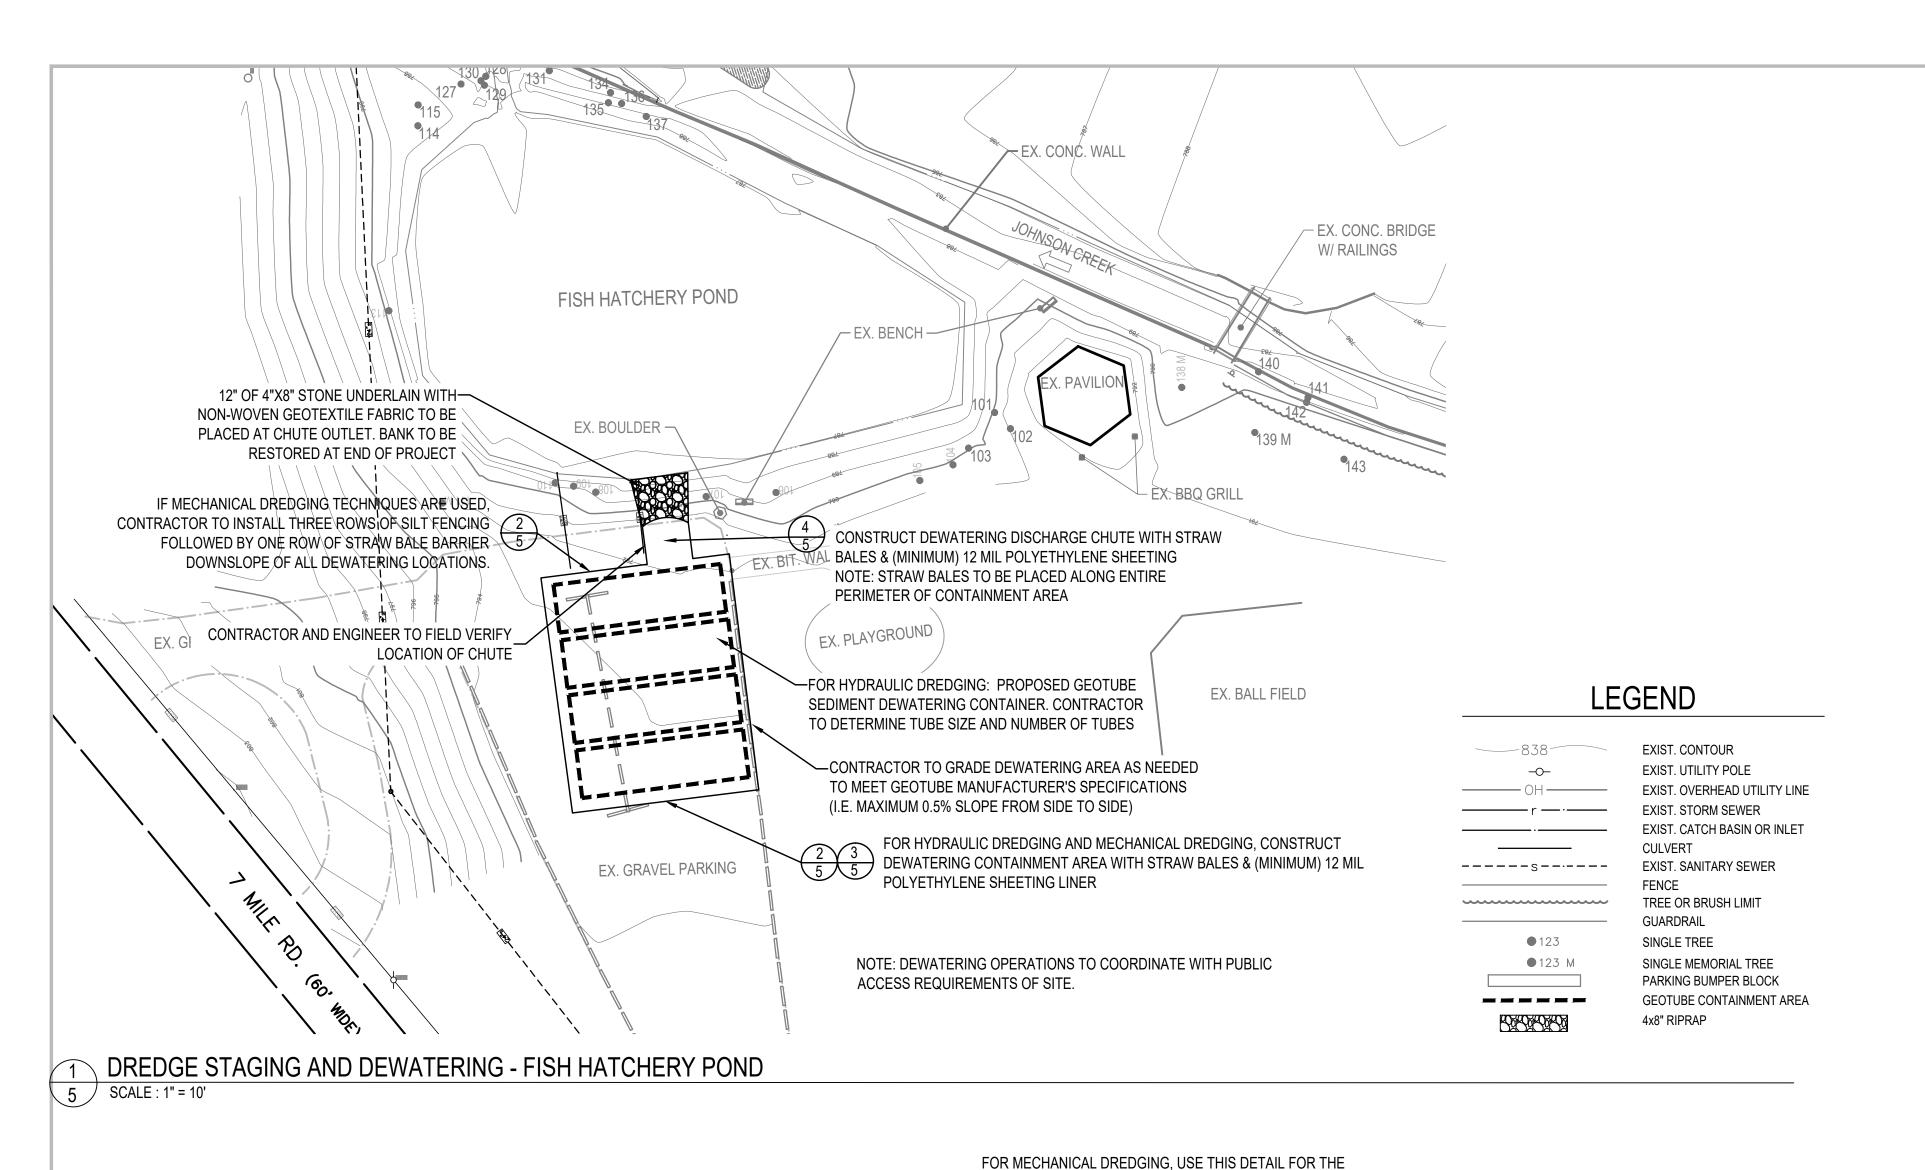
100% DESIGN DRAWINGS PERMIT APPLICATION PRE-APPLICATION MEETING CLIENT MEETING <u>5-1-19</u> PRELIMINARY DESIGN ECT PROJECT NUMBER

DRAWN BY APPROVED BY

SHEET TITLE

DEMOLITION





GENERAL DREDGING NOTES

- 1. CONTRACTOR TO VERIFY EXISTING CONDITIONS, INCLUDING BATHYMETRY, PRIOR TO START OF WORK BY CONDUCTING A PRE-DREDGING SURVEY AS DESCRIBED IN THE SPECIFICATIONS.
- 2. IF CONTRACTOR'S BATHYMETRIC DATA DIFFERS FROM THE CONTRACT PLANS, CONTACT ENGINEER FOR RESOLUTION PRIOR TO
- 3. CONTRACTOR MAY CHOOSE TO REMOVE SEDIMENT FROM FISH HATCHERY POND BY EITHER MECHANICAL OR HYDRAULIC DREDGING TECHNIQUES OR BOTH.
- 4. CONTRACTOR TO SUBMIT A DREDGING PLAN AND PROJECT SCHEDULE TO THE PROJECT ENGINEER FOR APPROVAL PRIOR TO START
- 5. EXISTING POND BOTTOM SEDIMENTS MAY BE SOFT AND TEMPORARY HAUL ROADS ALONG THE LAKE BOTTOM MAY BE NECESSARY TO FACILITATE CONSTRUCTION TRAFFIC DURING RESTORATION ACTIVITIES. CONTRACTOR TO VERIFY EXISTING CONDITIONS PRIOR TO ACCESSING THE DREDGE AREAS.
- REMOVE SEDIMENT FROM FISH HATCHERY POND TO PROPOSED ELEVATIONS AS SHOWN ON THE DRAWINGS.
- 7. CONTRACTOR TO ESTABLISH AND MAINTAIN STAGING AREA AND DEWATERING CONTAINMENT AREA AS SHOWN ON THE DRAWINGS.
- 8. CONTRACTOR SHALL DEWATER, LOAD, AND TRANSPORT SEDIMENT AND DEBRIS REMOVED FROM THE POND. CONTRACTOR TO ENSURE THAT SOILS HAVE A MINIMUM SOLIDS CONTENT BY WEIGHT OF 30% AND NO FREE LIQUIDS AS DESCRIBED IN THE SPECIFICATIONS OR AS REQUIRED BY THE LANDFILL FACILITY.
- 9. ALL DISCHARGE FROM DEWATERING ACTIVITIES SHALL BE FILTERED PRIOR TO INTRODUCTION INTO THE WATERWAY TO ELIMINATE POTENTIAL RELEASE OF SEDIMENTS.
- 10. ALL DREDGED MATERIAL TO BE DISPOSED OF AT A TYPE II LANDFILL.
- 11. THIS IS AN URBAN RIVER SYSTEM AND IT SHOULD BE ANTICIPATED THAT 'URBAN DEBRIS' MAY BE ENCOUNTERED.
- 12. CONTRACTOR IS RESPONSIBLE FOR STAKING AND DEMARCATING LIMITS OF EXCAVATION AND DREDGING. CONTRACTOR MAY UTILIZE WIRELESS INTEGRATED DREDGE POSITIONING TECHNOLOGY, SUCH AS 'CLAMVISION' OR SIMILAR TO CONTROL AND RECORD WORK PROGRESS. THIS INFORMATION WILL BE MADE AVAILABLE TO ENGINEER UPON REQUIST AND/OR FURNISH AS PART OF PAY REQUESTS AS DESCRIBED IN THE SPECIFICATIONS.
- 13. CONTRACTOR TO COMPLETE SOUNDINGS WHEN NEARING COMPLETION OF DREDGING WORK AND SUBMIT TO ENGINEER AS DESCRIBED IN THE SPECIFICATIONS.
- 14. CONTRACTOR TO COMPLETE POST-DREDGING SEDIMENT ELEVATION SURVEYS FOR THE PROPOSED AREA OF WORK WITHIN FISH HATCHERY POND. ENGINEER TO APPROVE POST-CONSTRUCTION SURVEY PRIOR TO CONTRACTOR DEMOBILIZING AND PROCEEDING WITH RESTORATION ACTIVITIES.
- 15. CONTRACTOR IS RESPONSIBLE FOR MAINTAINING THE RETURN FLOW OF EFFLUENT WATER BACK TO FISH HATCHERY POND WITHIN THE EXISTING DEWATERING AREA.
- 16. CONTRACTOR TO ENSURE THAT RETURN WATER DOES NOT CAUSE EROSION AT ANY TIME.


MECHANICAL DREDGING NOTES:

- IF MECHANICAL DREDGING TECHNIQUES ARE USED, THREE ROWS OF SILT FENCING FOLLOWED BY ONE ROW OF STRAW BALE FILTER
 MUST BE INSTALLED DOWNSLOPE OF ALL DEWATERING LOCATIONS. THE STRAW BALE FILTER SHOULD BE INSTALLED DOWNSLOPE
 OF THE SILT FENCE ROWS.
- 2. FOR MECHANICAL DREDGING, A DEWATER CONTAINMENT AREA SHALL BE CONSTRUCTED. STRAW BALES WITH IMPERMEABLE PLASTIC LINER TO BE USED AROUND PERIMETER TO CONTAIN SEDIMENTS AND WATER. IMPERMEABLE LAYER NOT TO BE USED ON GRADE.

HYDRAULIC DREDGING NOTES:

- 1. FOR HYDRAULIC DREDGING, GEOTUBES (OR APPROVED EQUAL) MUST BE USED TO SUFFICIENTLY DEWATER SEDIMENTS.
- 2. CONTRACTOR TO CONFIGURE STAGING AREA TO INCLUDE A GEOTUBE CONTAINMENT AREA WITH STRAW BALES INSTALLED AROUND ITS PERIMETER TO A HEIGHT AS SPECIFIED BY THE MANUFACTURER.
- 3. CONTRACTOR TO GRADE DEWATERING AREA AS NEEDED TO MEET GEOTUBE MANUFACTURER'S SPECIFICATIONS.
- 4. NO MORE THAN 0.5% GRADE FROM END TO END OF THE GEOTUBE CONTAINMENT AREA AND SHALL BE FREE OF ANY DEBRIS OR SHARP OBJECTS THAT MAY PUNCTURE THE PERMEABLE MEMBRANE OF THE GEOTUBE.
- SHARP OBJECTS THAT MAY PUNCTURE THE PERMEABLE MEMBRANE OF THE GEOTUBE.

 5. GEOTUBE CONTAINMENT AREA TO BE SLOPED TOWARD THE POND WITH SWALE DIRECTED TOWARD POND.
- 6. CONTRACTOR IS RESPONSIBLE FOR ORDERING THE APPROPRIATE NUMBER OF GEOTUBE DEWATERING CONTAINERS TO PROVIDE ADEQUATE REMOVAL OF SEDIMENTS VIA HYDRAULIC DREDGING.

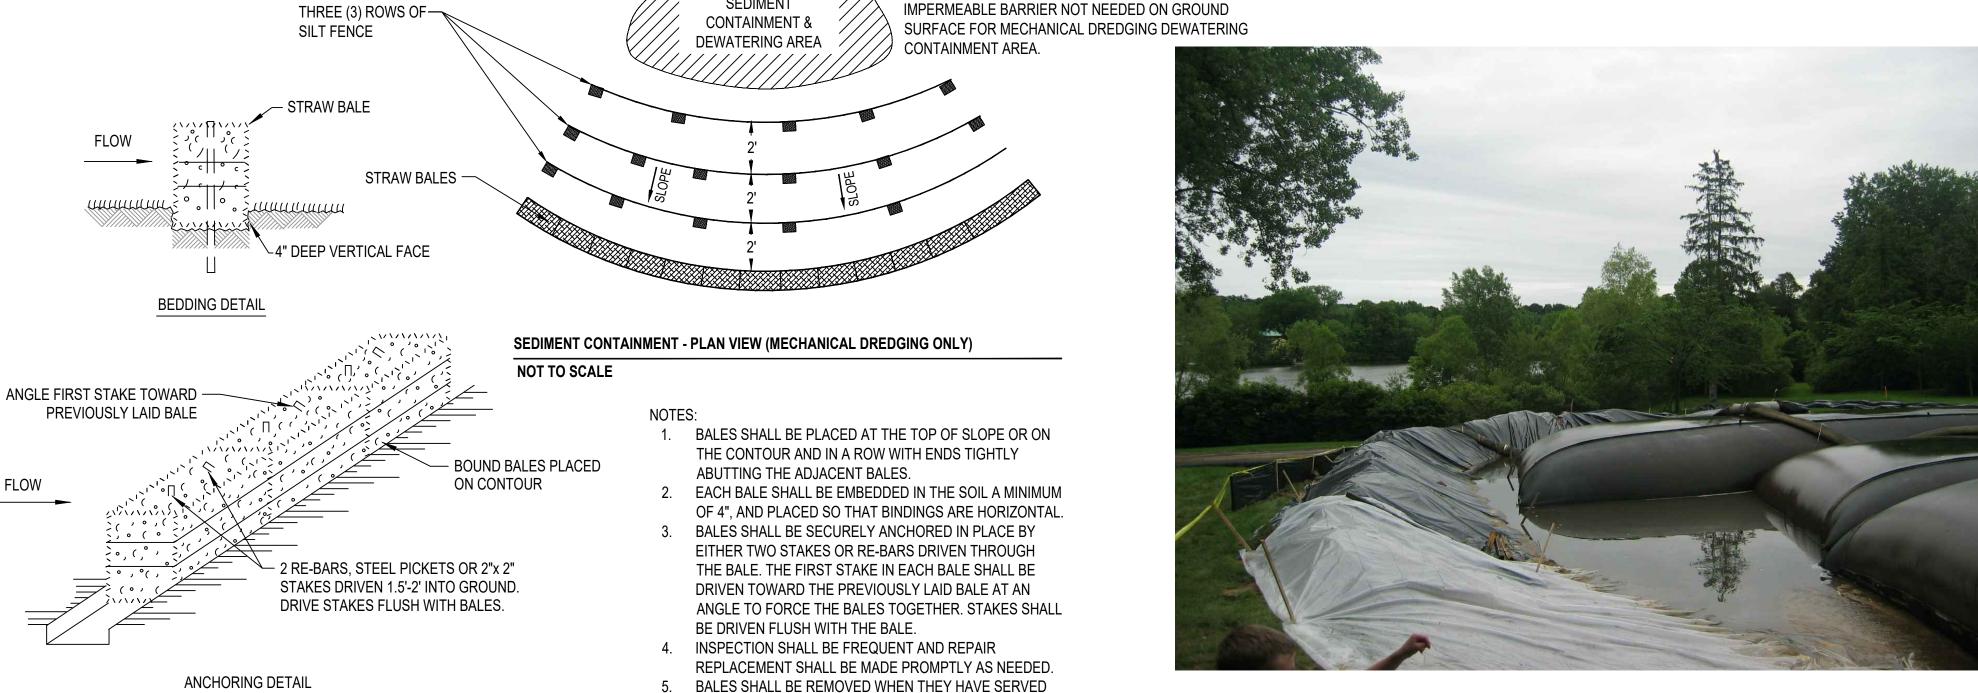

THEIR USEFULNESS SO AS NOT TO BLOCK OR IMPEDE


STORM FLOW OR DRAINAGE.

DOWN GRADIENT AREA. STRAW BALES WITH

PERIMETER TO CONTAIN SEDIMENT AND WATER.

IMPERMEABLE BARRIER TO BE USED AROUND ENTIRE

3 EXAMPLE GEOTUBE® CONTAINMENT AREA (HYDRAULIC DREDGING ONLY)
5 NOT TO SCALE

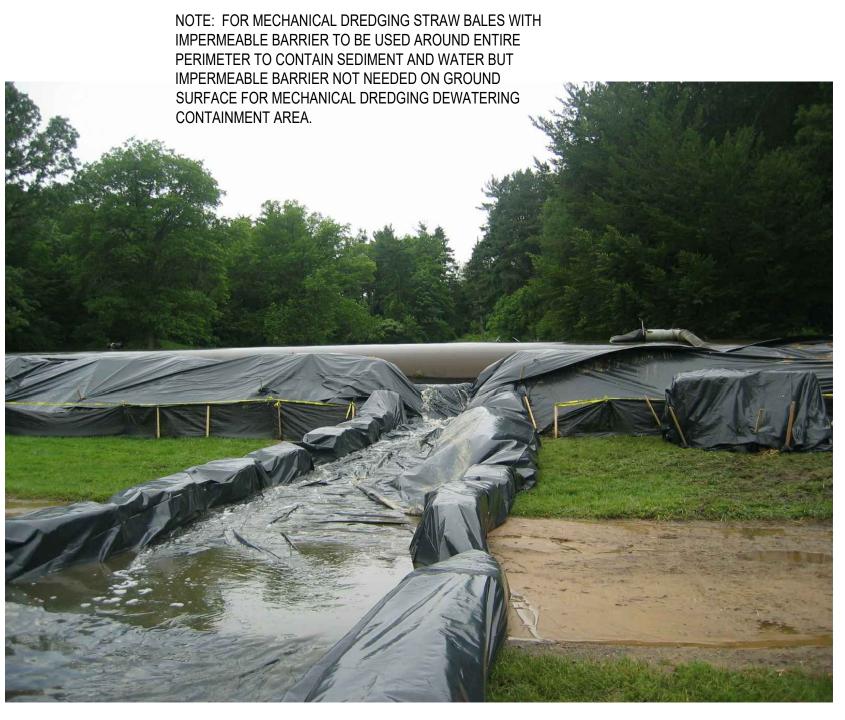

EXAMPLE GEOTUBE® DEWATERING CHUTE (HYDRAULIC DREDGING ONLY)

NOT TO SCALE

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Alliance
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ROUGE RIVER AOC
JOHNSON CREEK FISH HATCHERY
PARK HABITAT
RESTORATION
PROJECT

ALLIANCE OF ROUGE COMMUNITIES

NORTHVILLE, WAYNE COUNTY, MICHIGAN

FOR BIDDING 3-2020
100% DESIGN DRAWINGS 2-2020
PERMIT APPLICATION 9-2019
PRE-APPLICATION MEETING 7-26-19
CLIENT MEETING 5-1-19
PRELIMINARY DESIGN 2-26-19

180611
ECT PROJECT NUMBER
AAB AAB

DREDGE
STAGING AND
DEWATERING


SCALE: 1" = 20' @ 22" x 34" 0 10' 20' 40'


DETAILS


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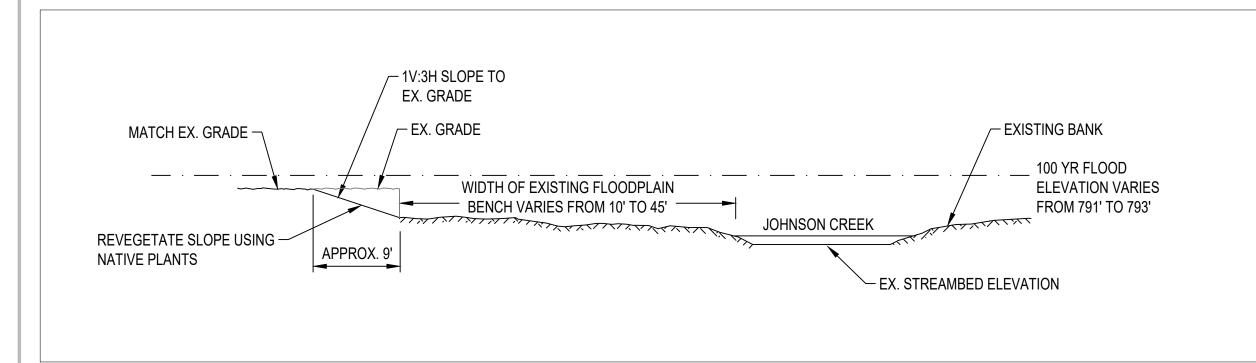
STRAW BALE BARRIER DETAIL






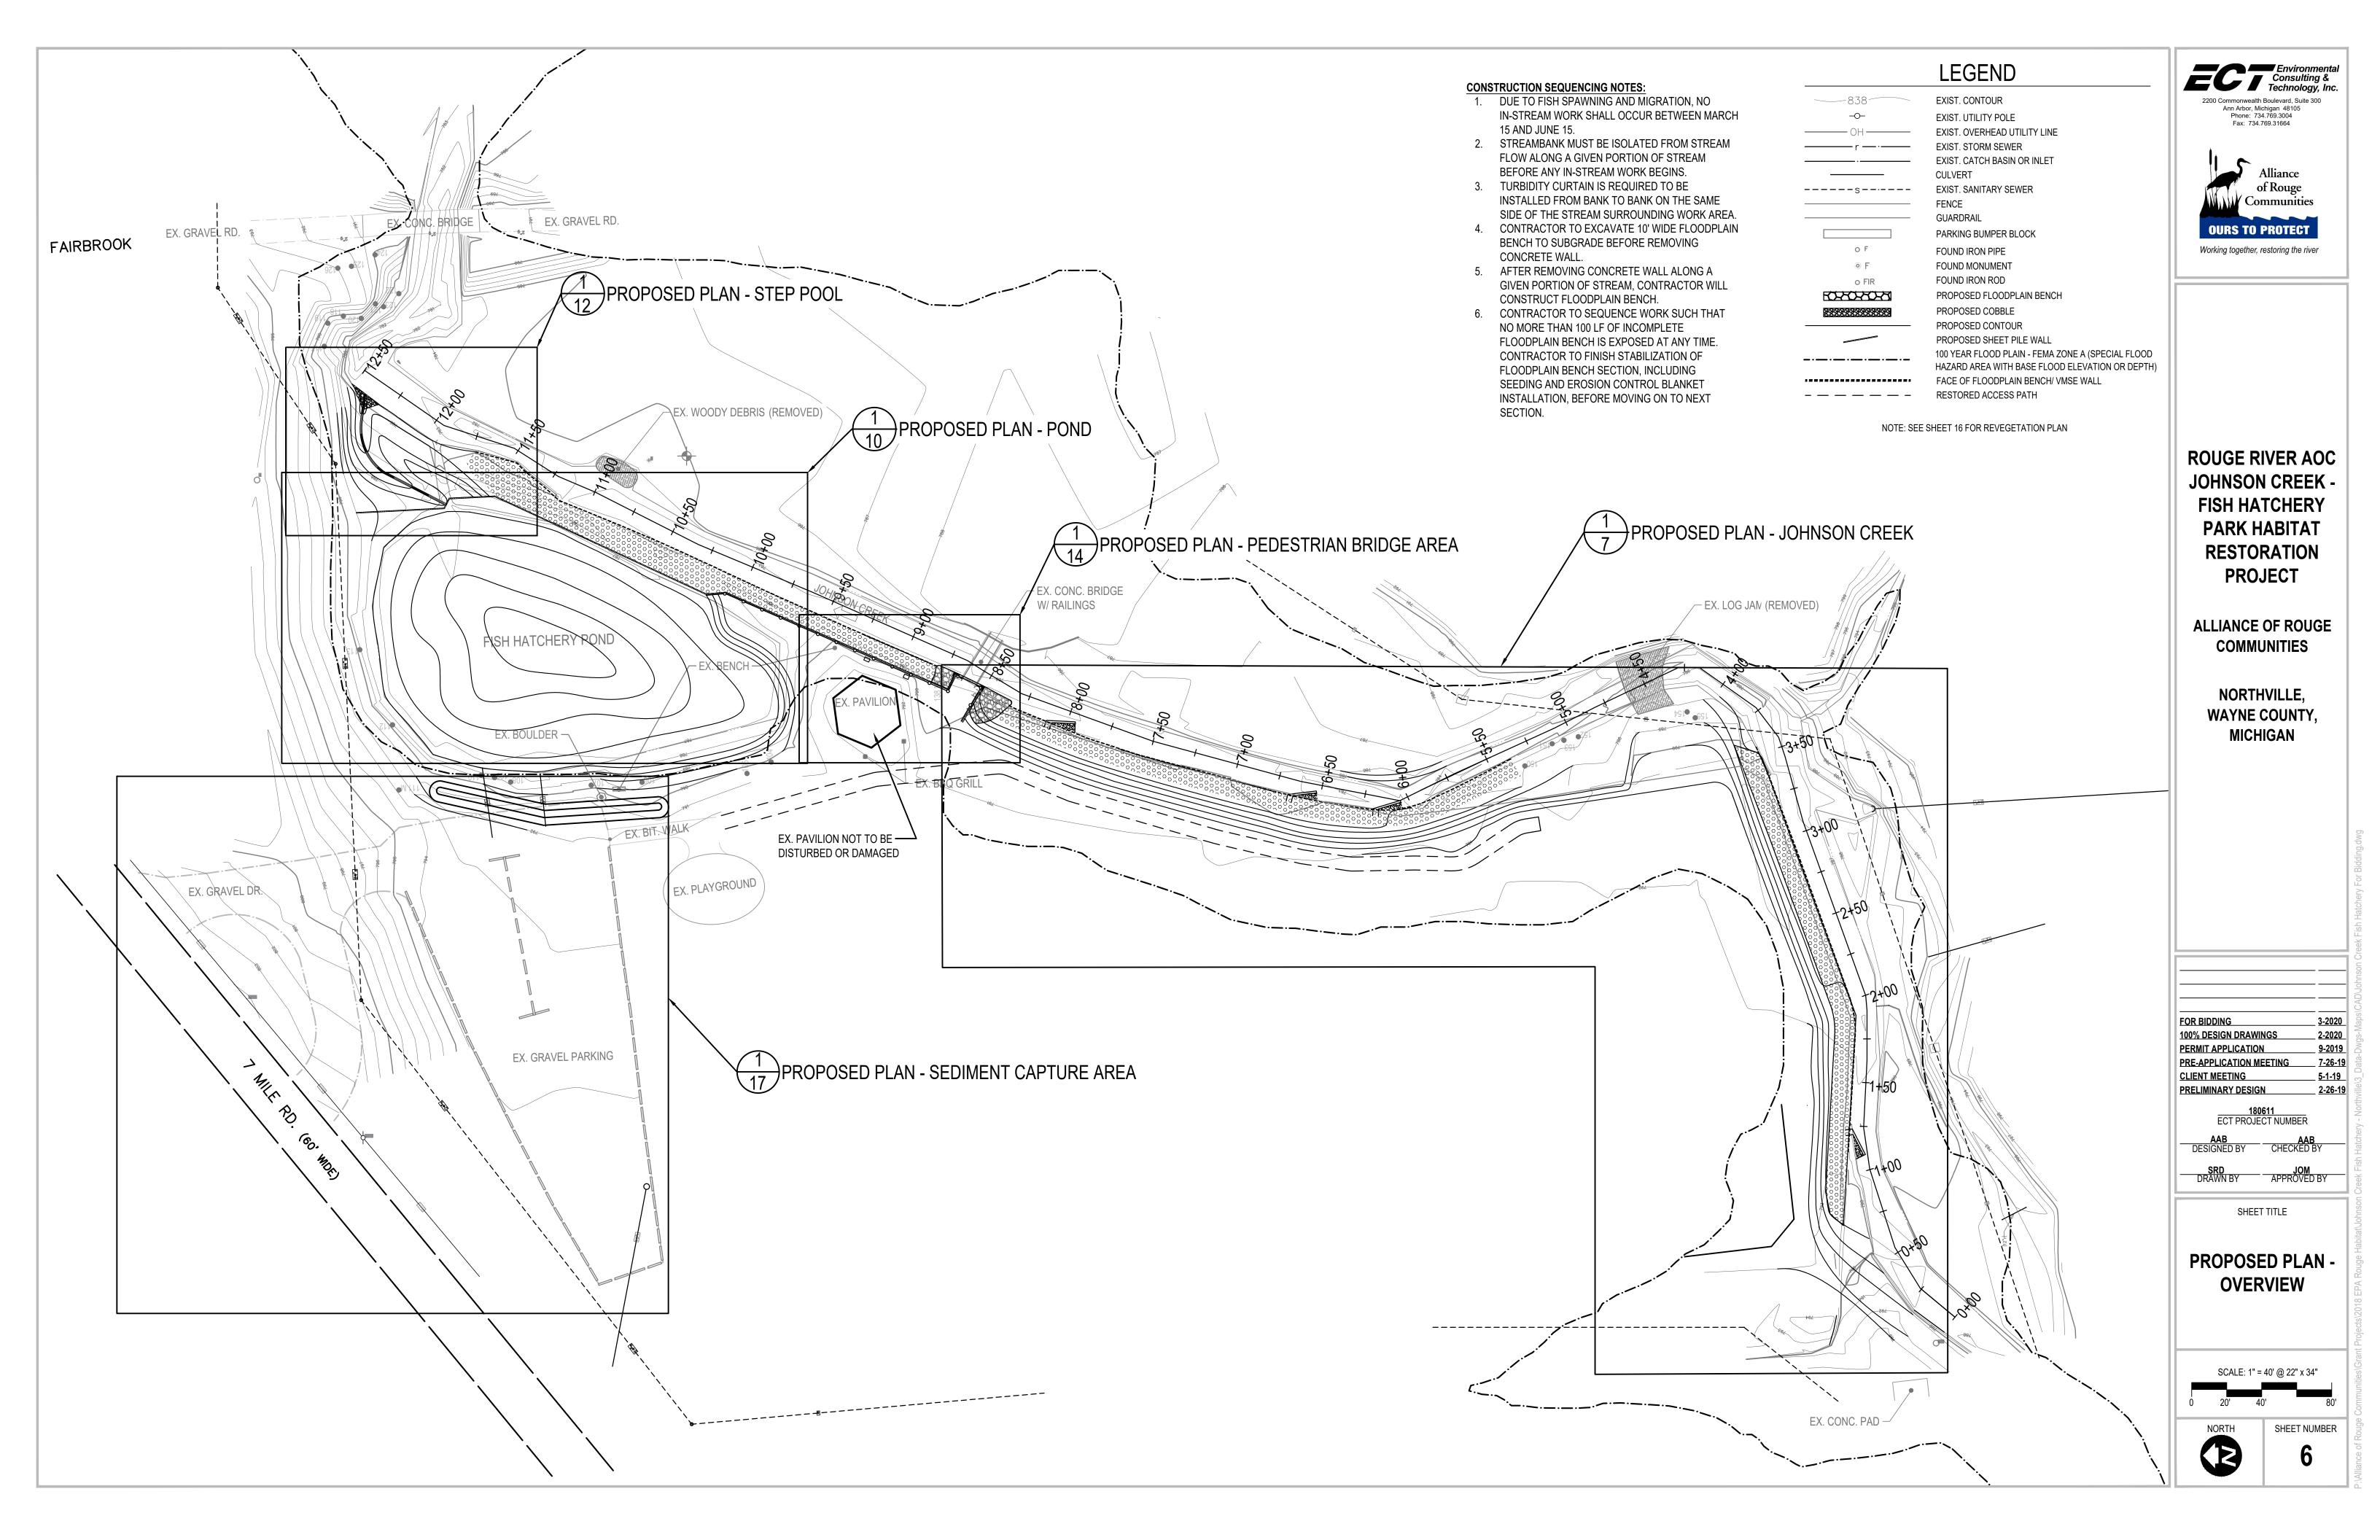

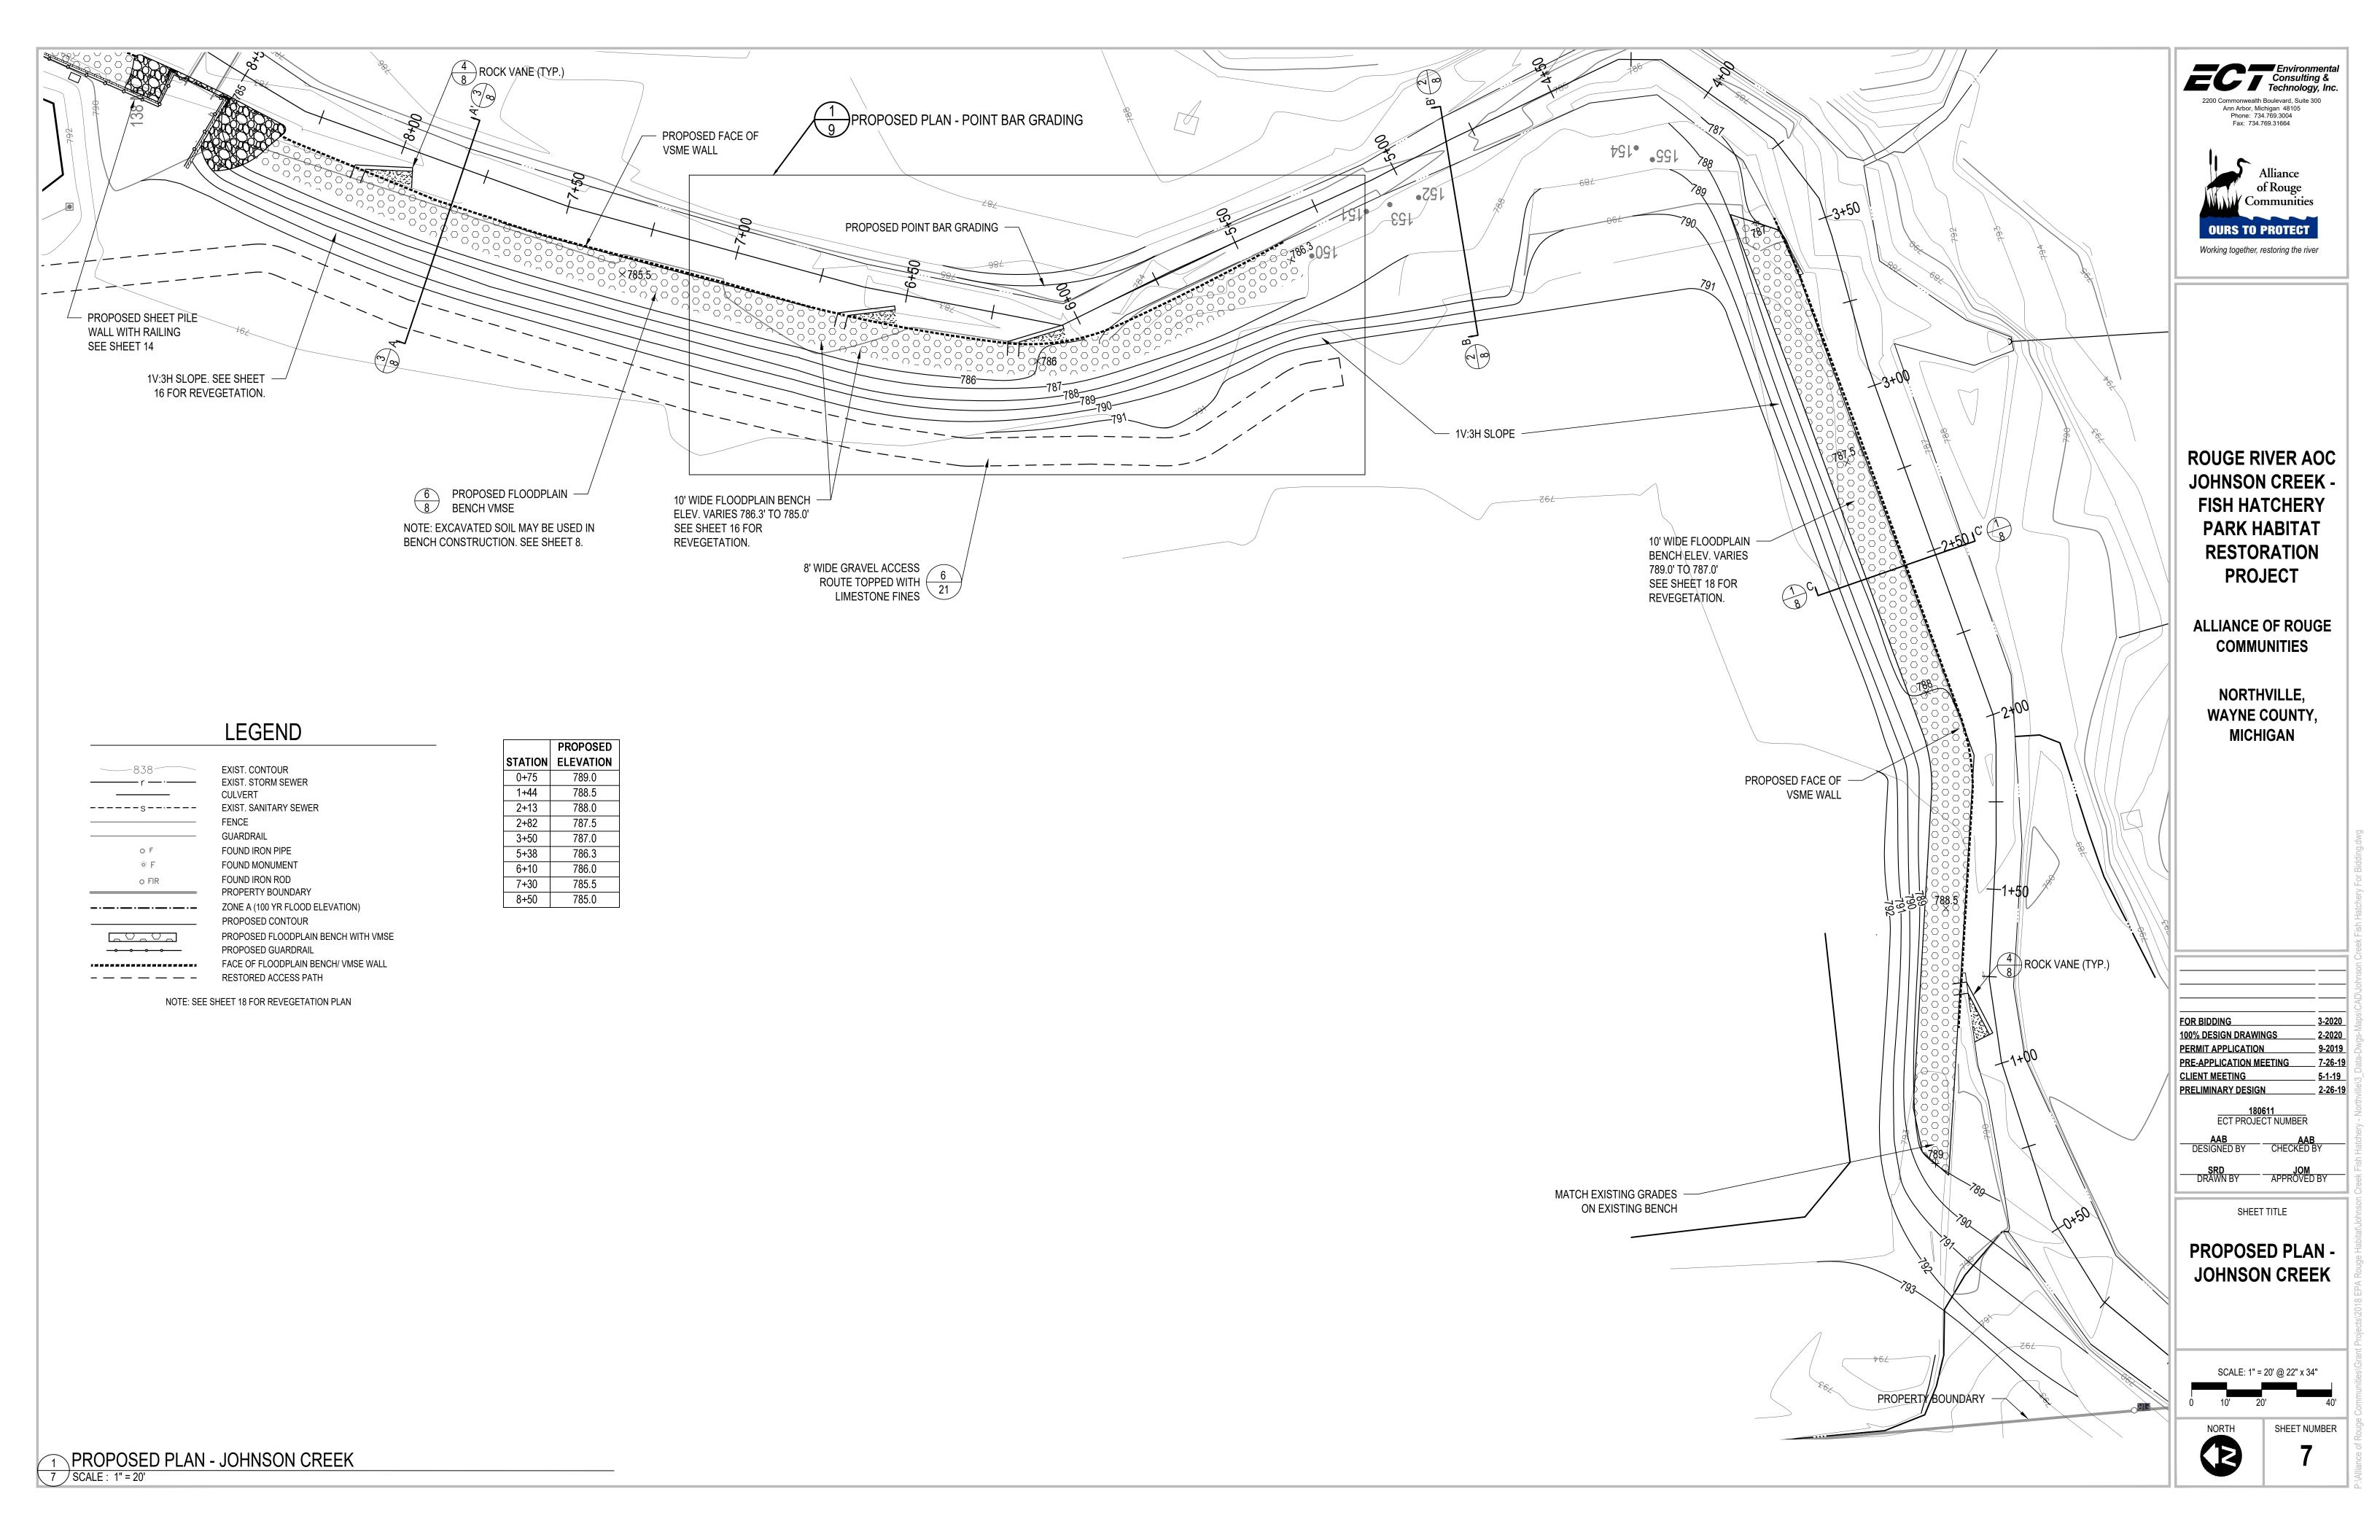
TYPICAL SECTION C-C' (STA 0+85 TO 3+53) 8 | SCALE : 1" = 10'

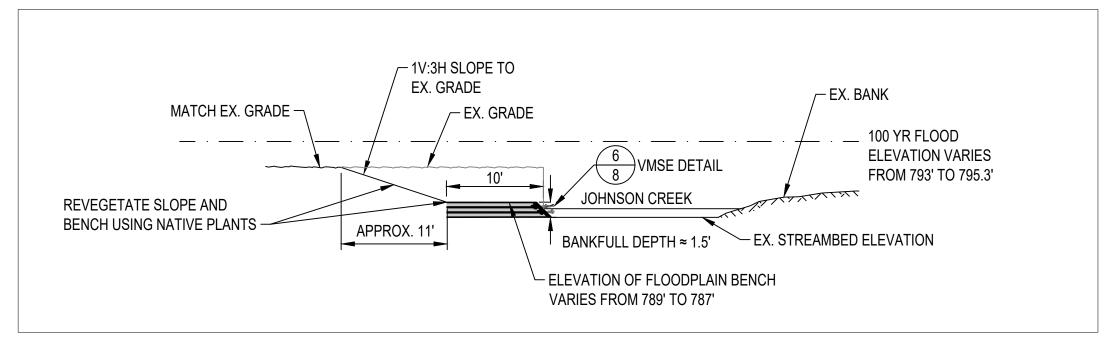


TYPICAL SECTION B-B' (STA 3+53 TO 5+38) 8 SCALE : 1" = 10'

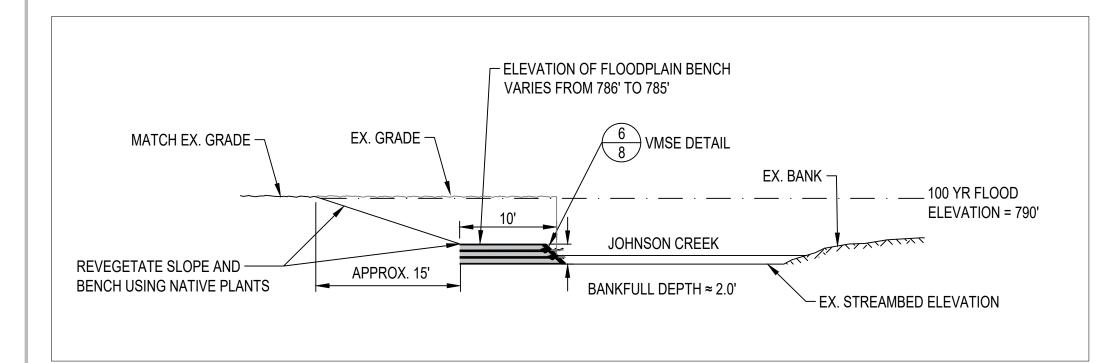


TYPICAL SECTION A-A' (STA 5+38 TO 8+54) 8 | SCALE : 1" = 10'

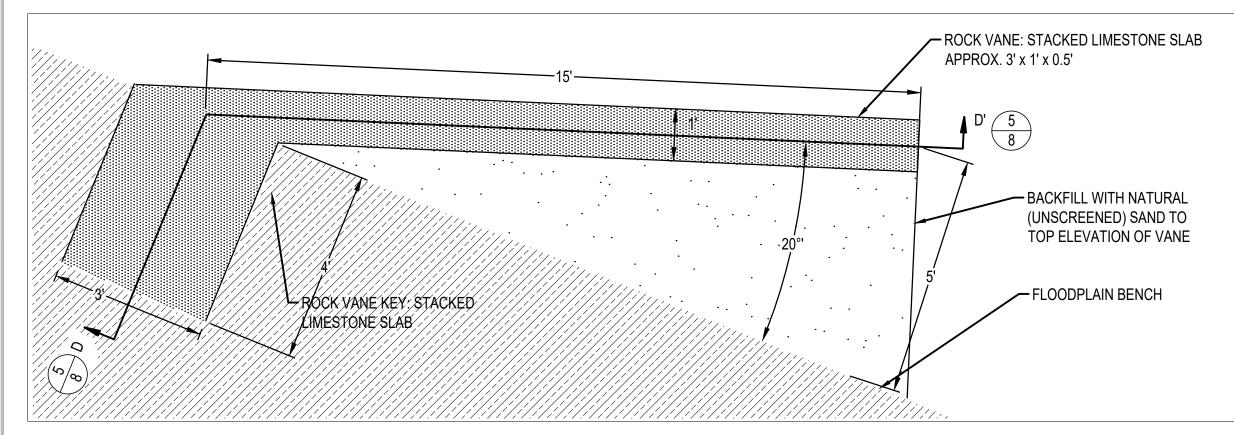

TYPICAL ROCK VANE - PLAN VIEW 8 | SCALE : 1" = 2'

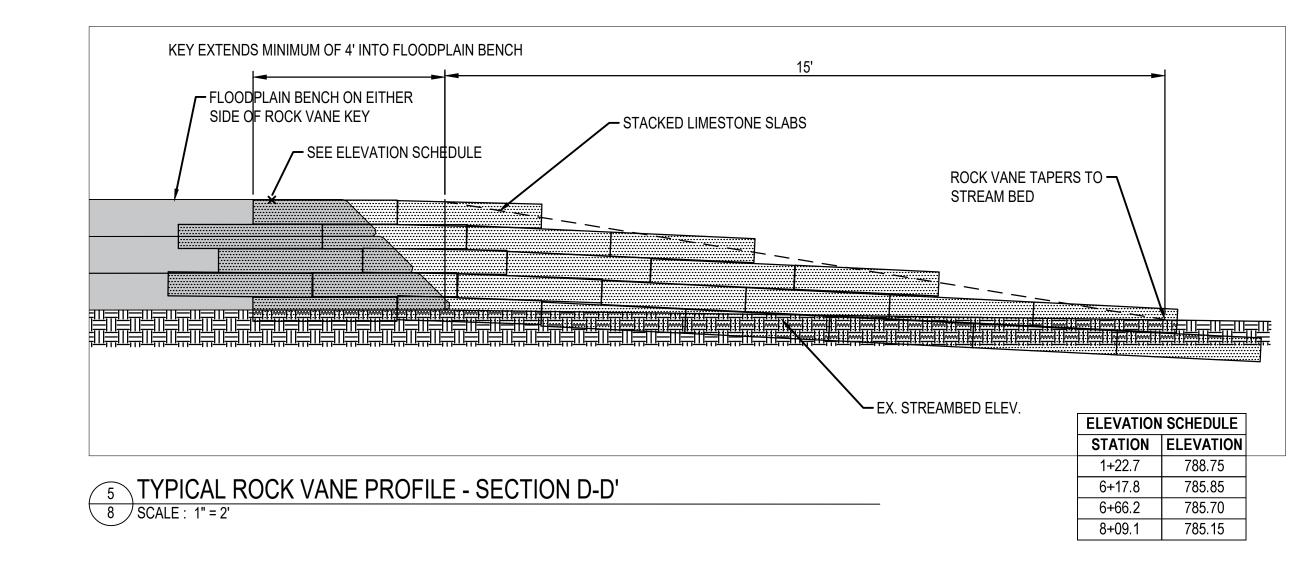

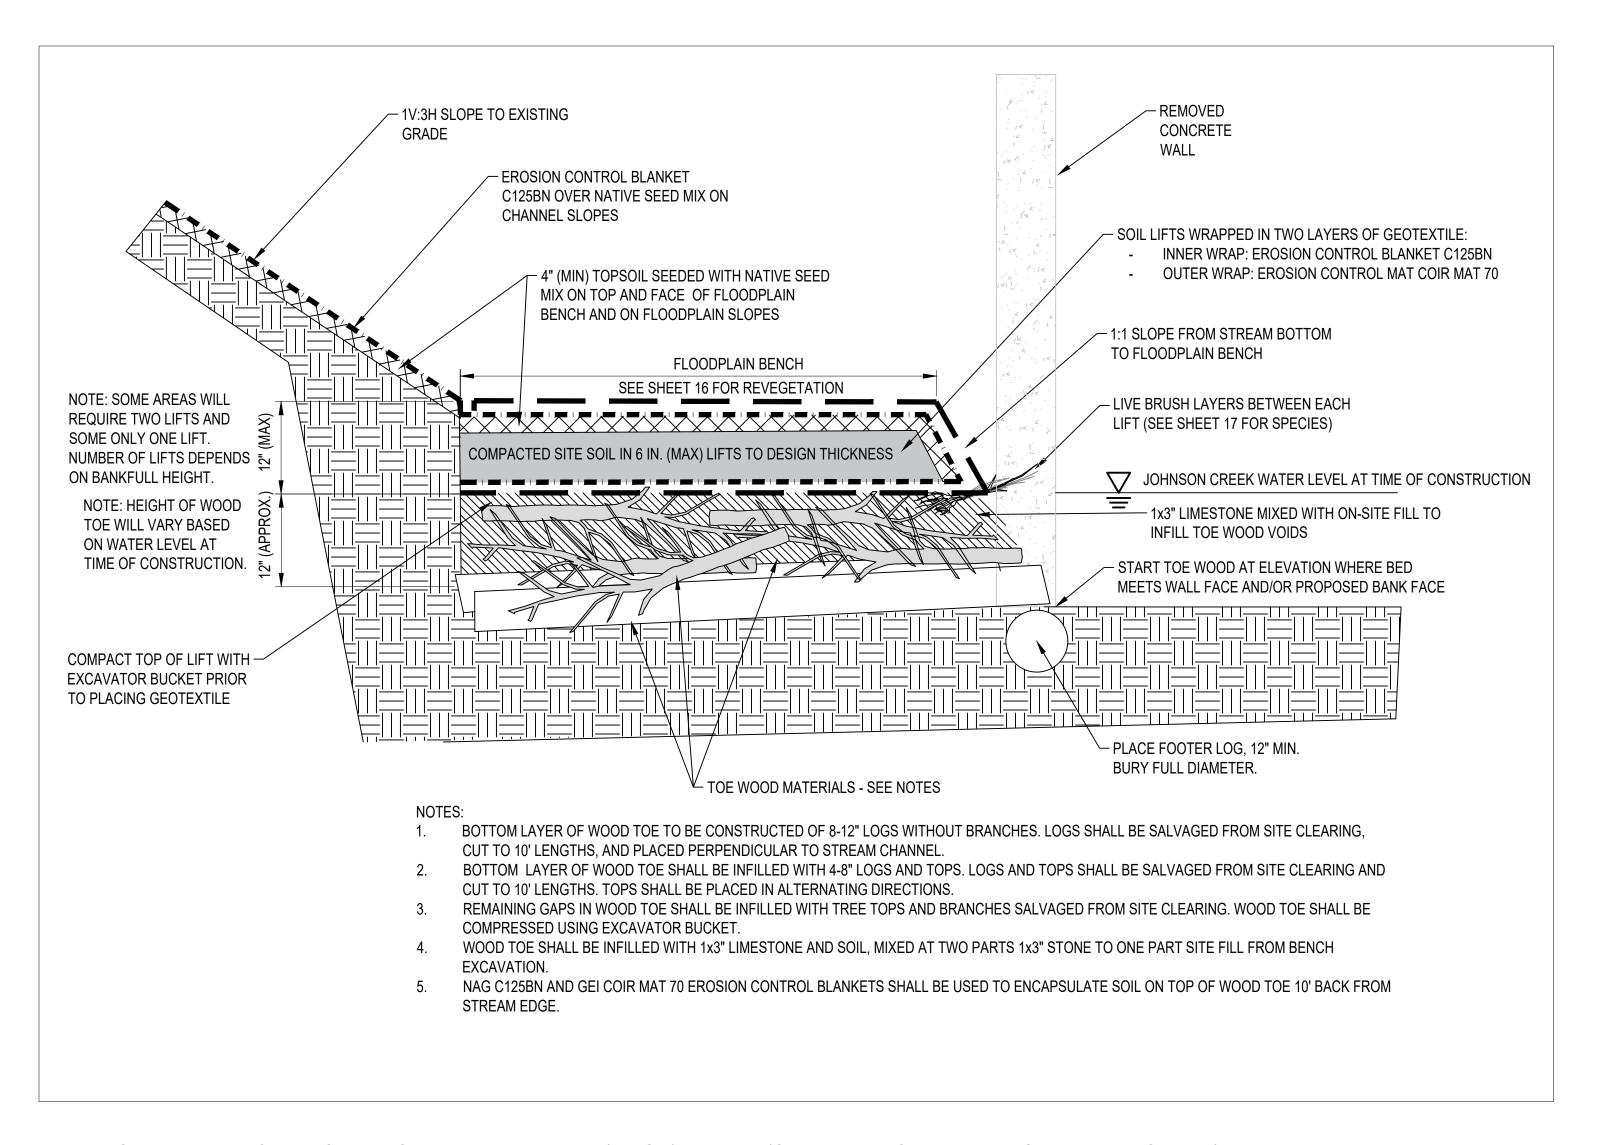

VEGETATED MECHANICALLY-STABILIZED EARTH (VMSE) DETAIL (STA. 0+85 TO 3+53 AND STA. 5+38 TO 8+54) 8 NOT TO SCALE

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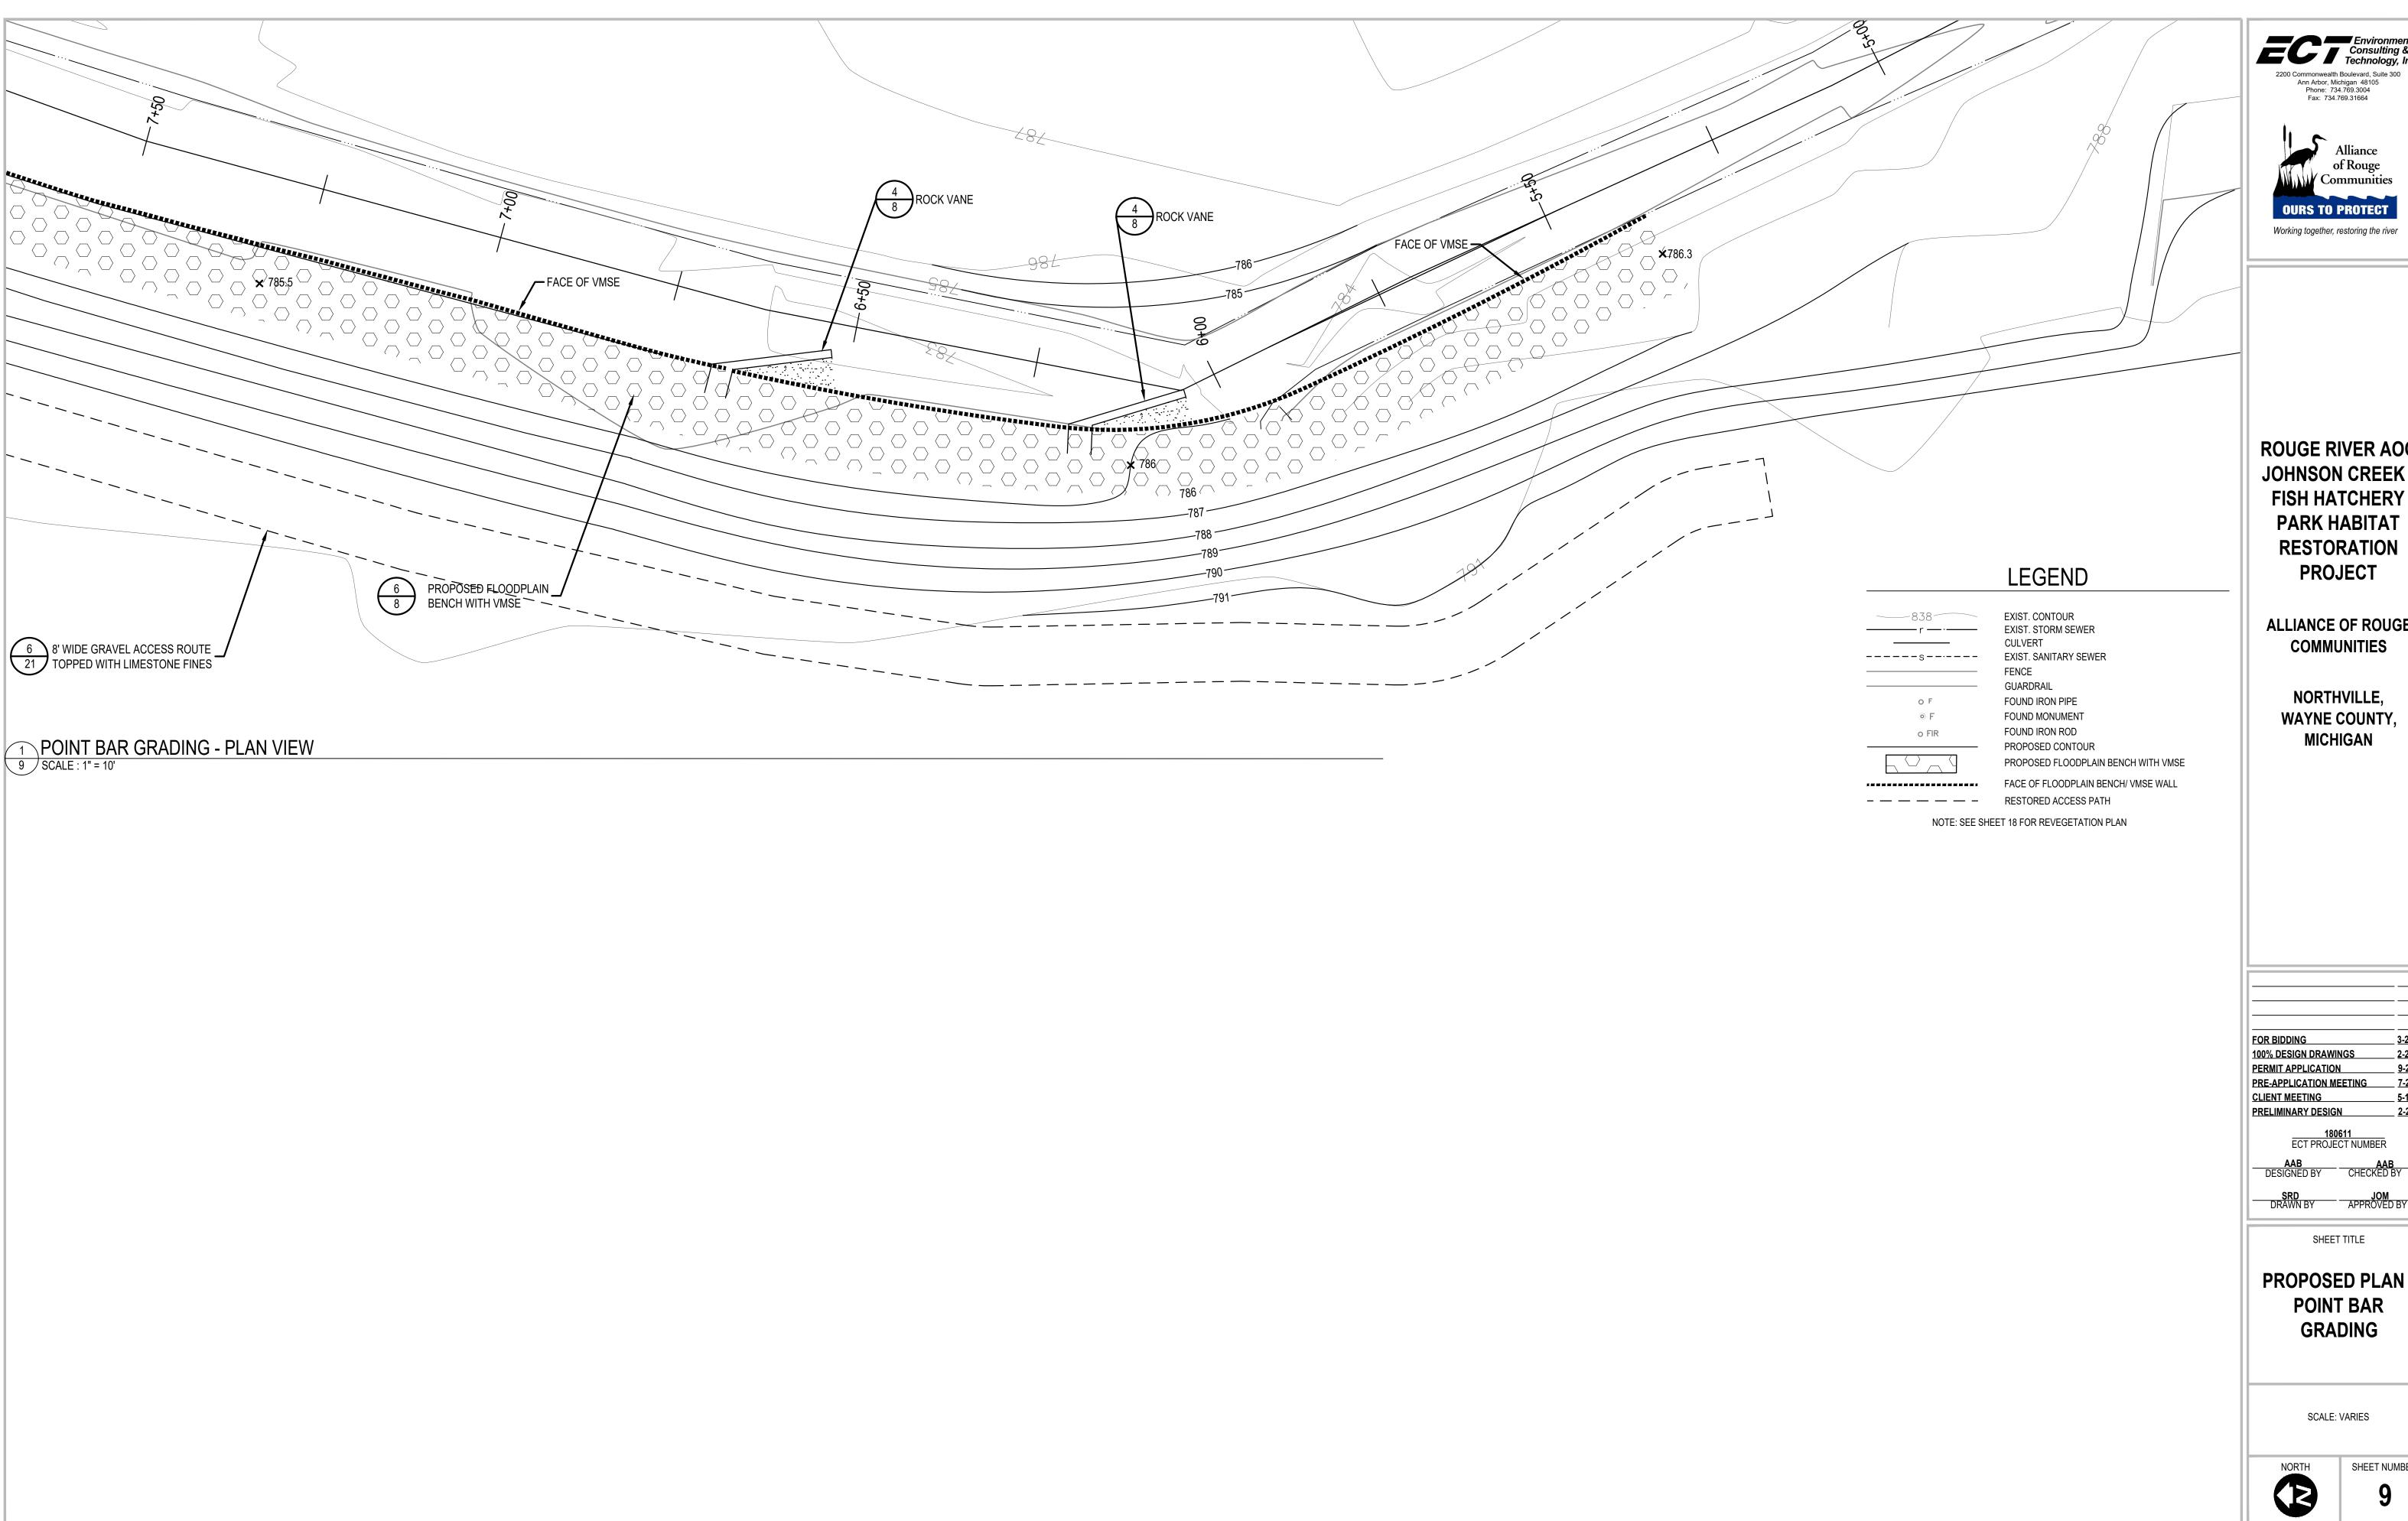
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PROPOSED CROSS **SECTIONS -JOHNSON CREEK**

SCALE: VARIES

B



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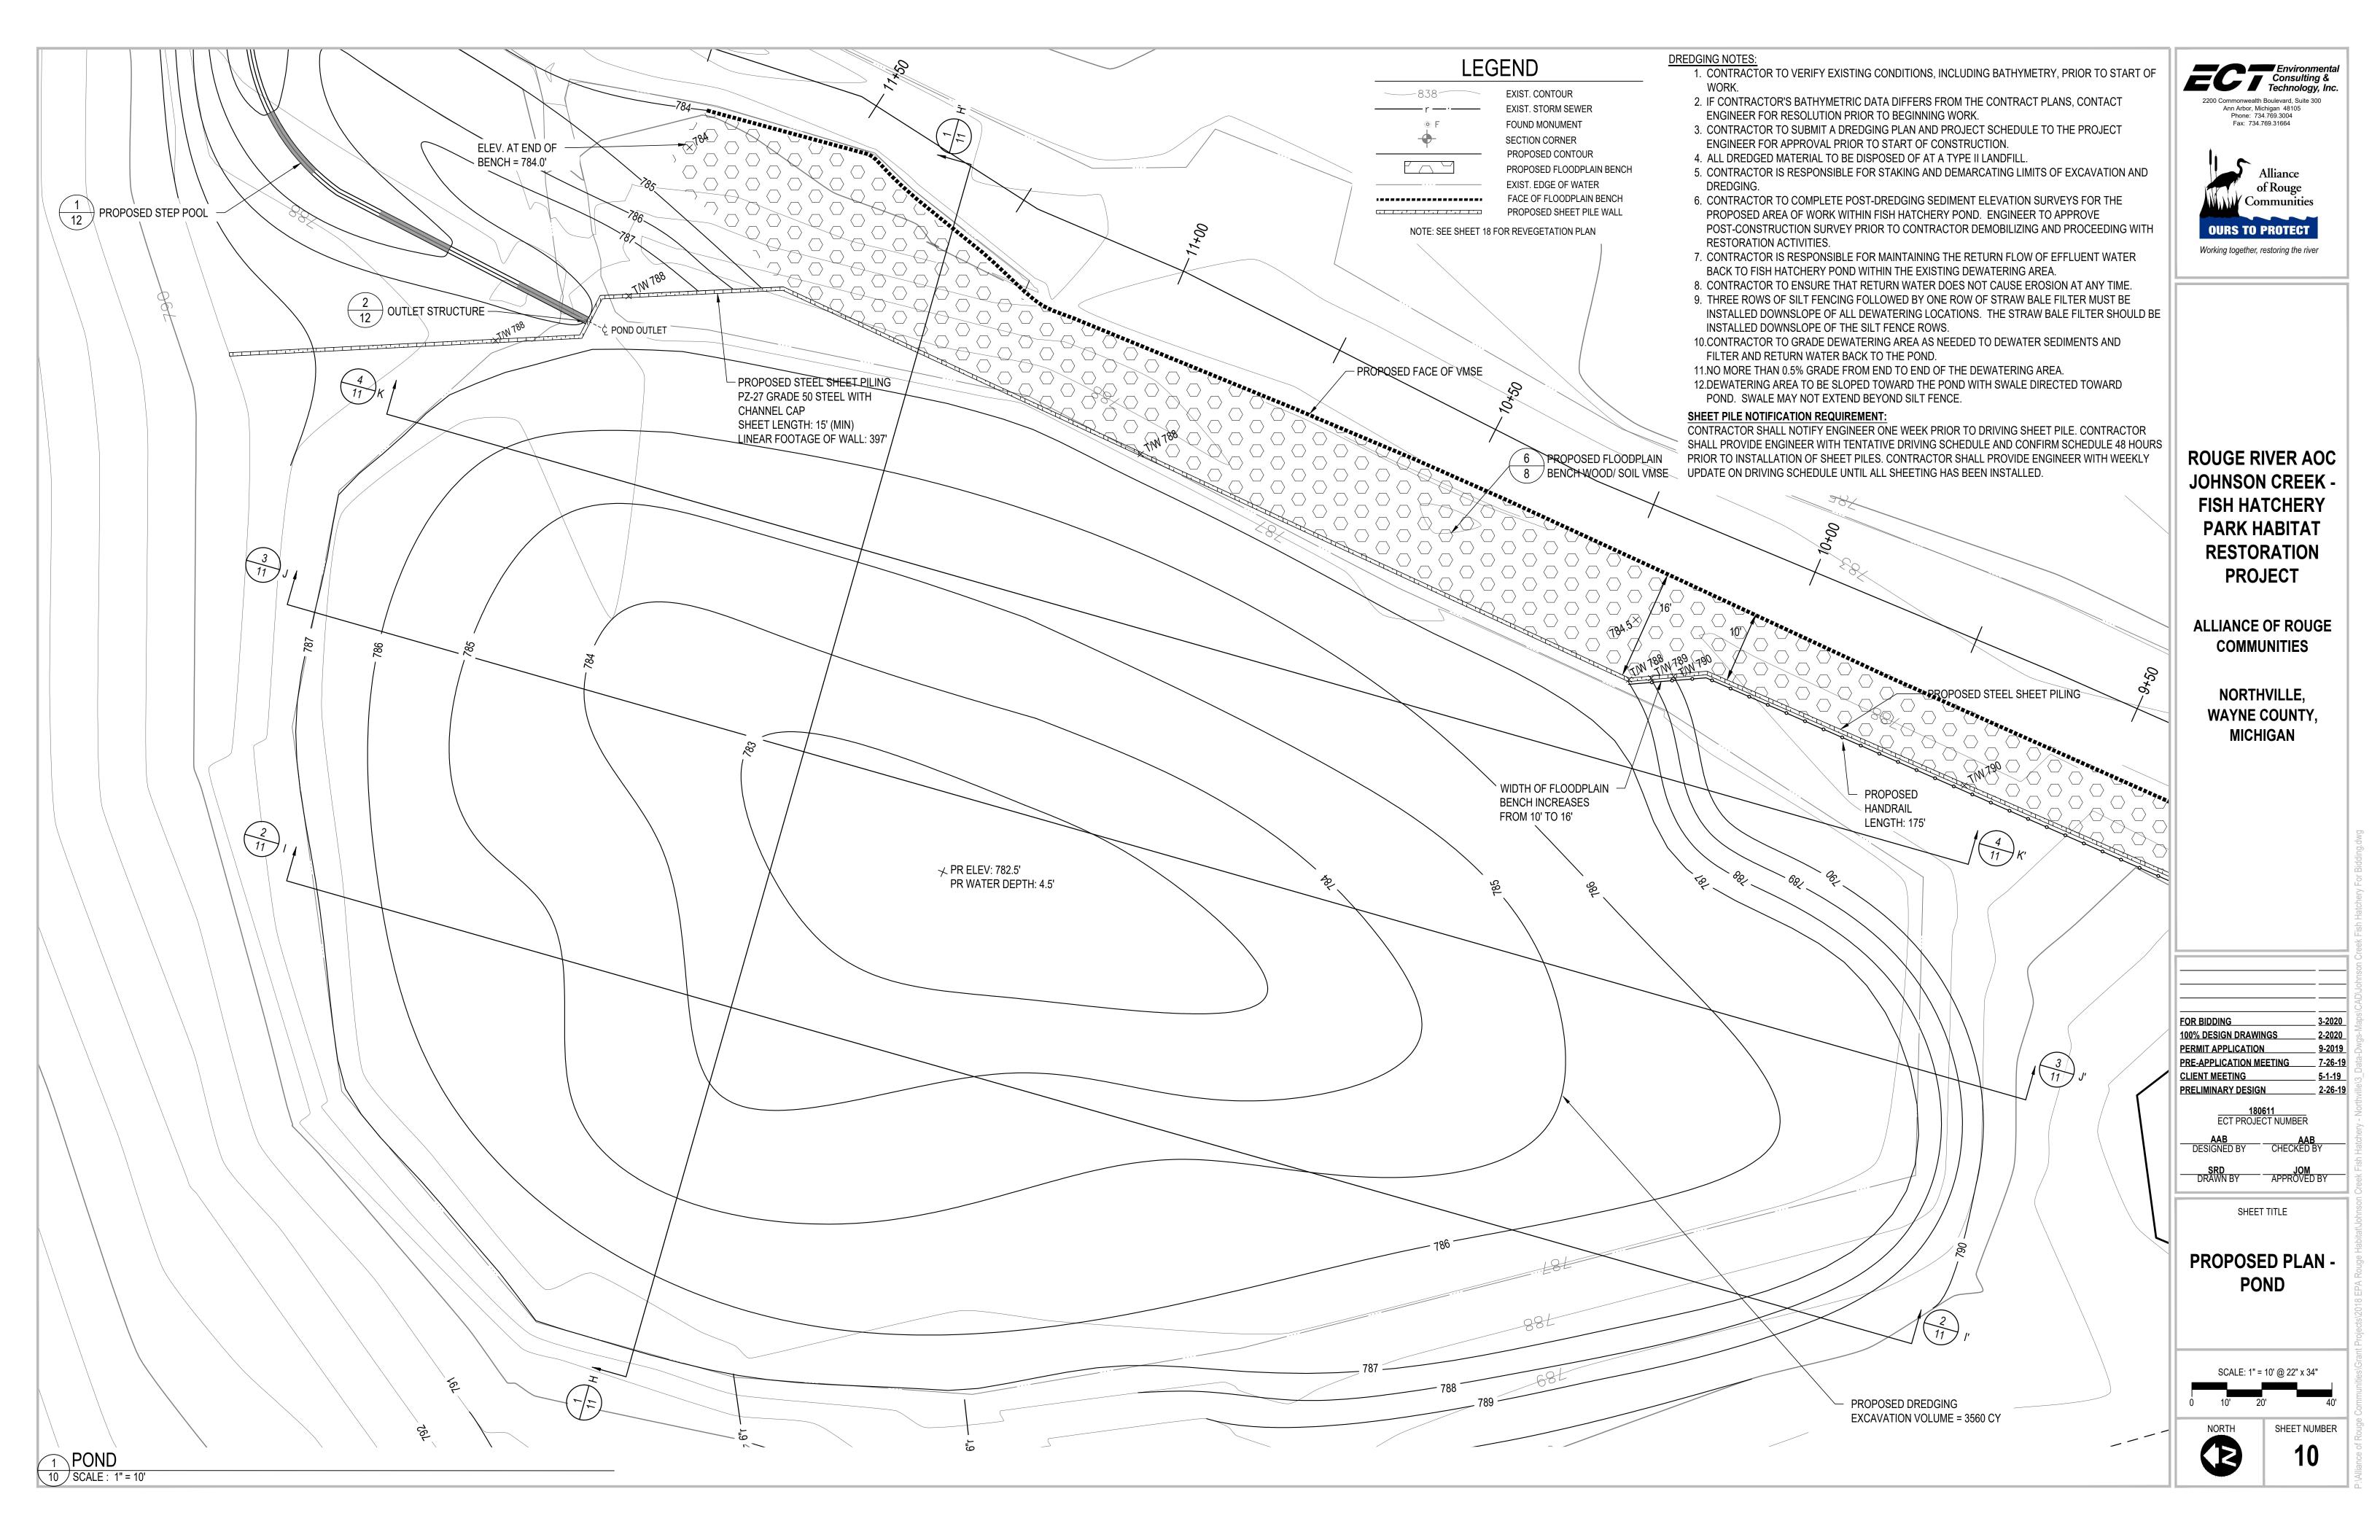
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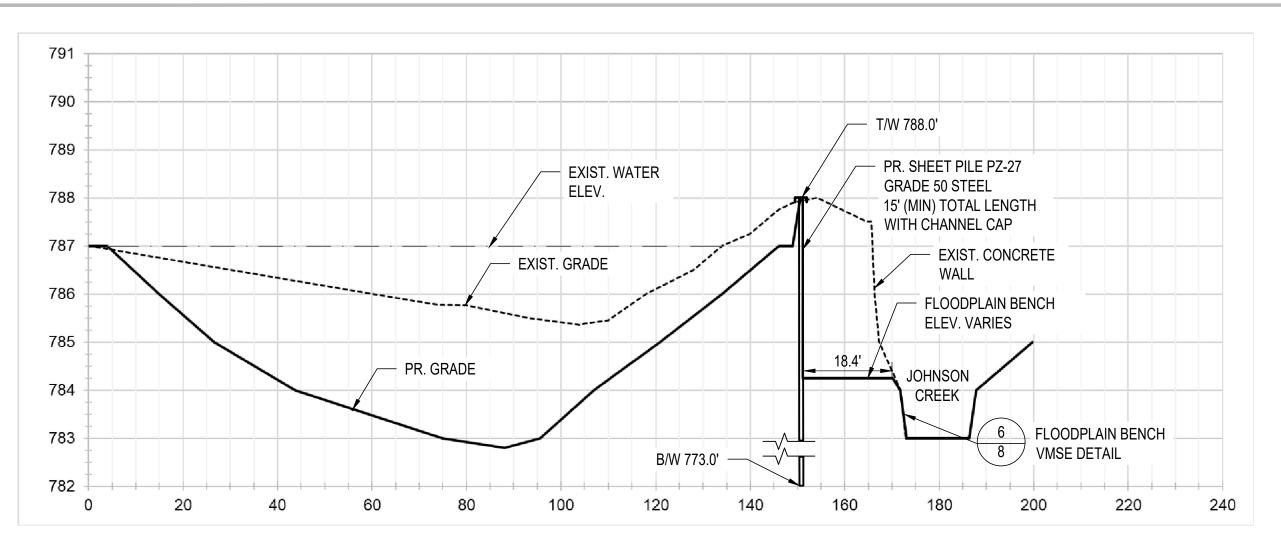
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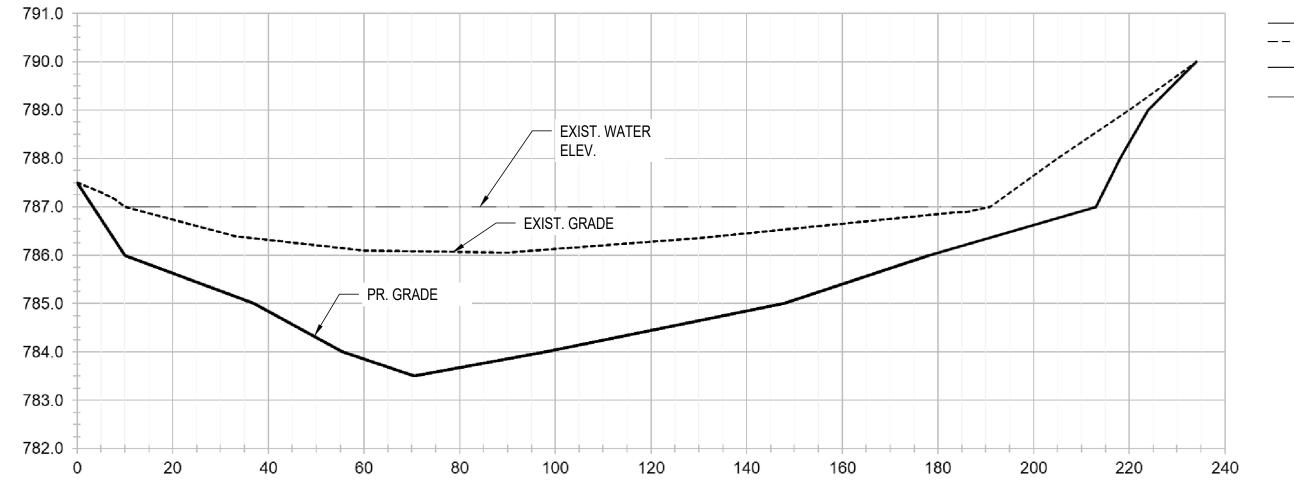
PROPOSED PLAN -**POINT BAR**

SCALE: VARIES












DREDGING OF FISH HATCHERY POND - CROSS SECTION I-I' 11 | SCALE - HORIZONTAL: 1" = 20' VERTICAL: 1" = 2'

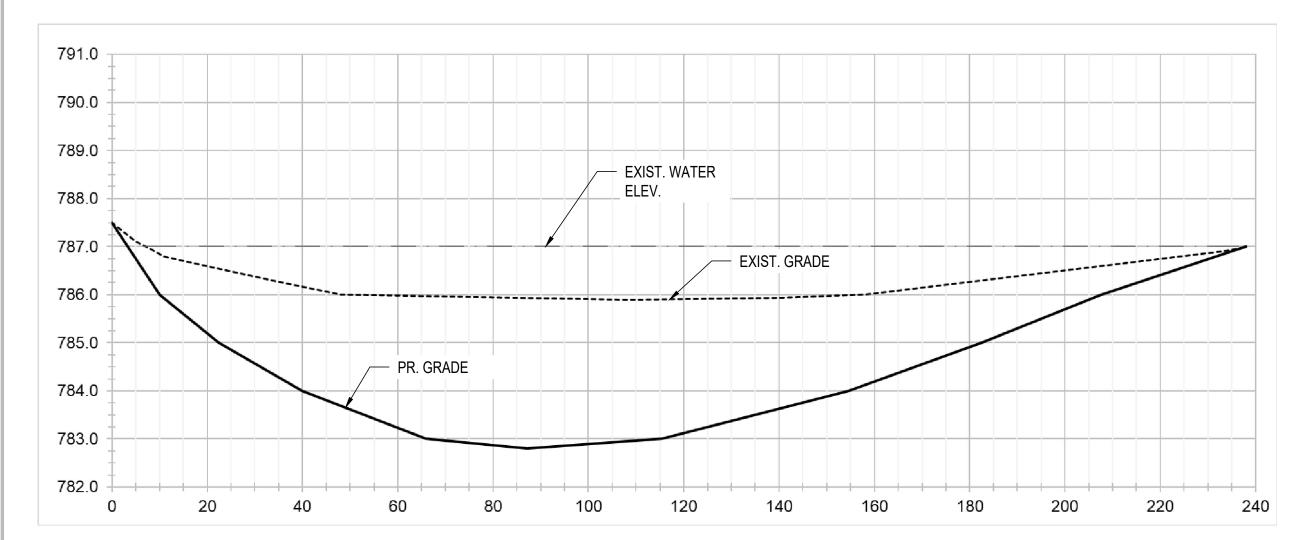

3 DREDGING OF FISH HATCHERY POND - CROSS SECTION J-J' 11 | SCALE - HORIZONTAL: 1" = 20' VERTICAL: 1" = 2'

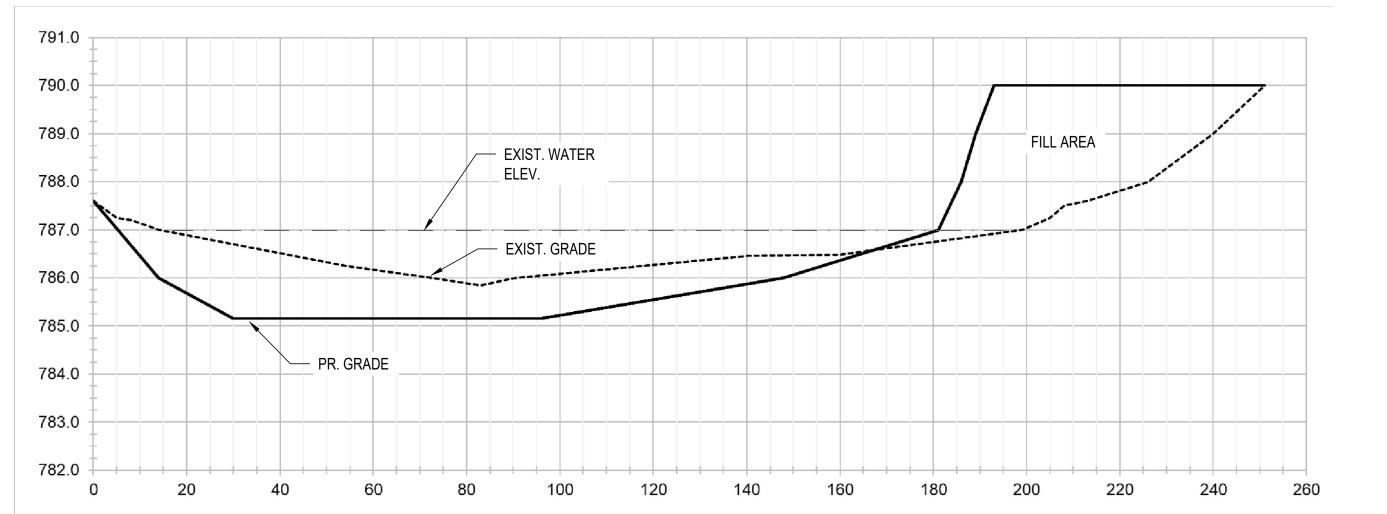

DREDGING OF FISH HATCHERY POND - CROSS SECTION K-K' 11 SCALE - HORIZONTAL: 1" = 20' VERTICAL: 1" = 2'

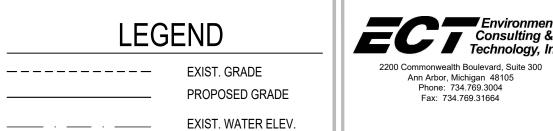



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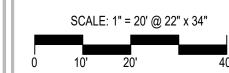
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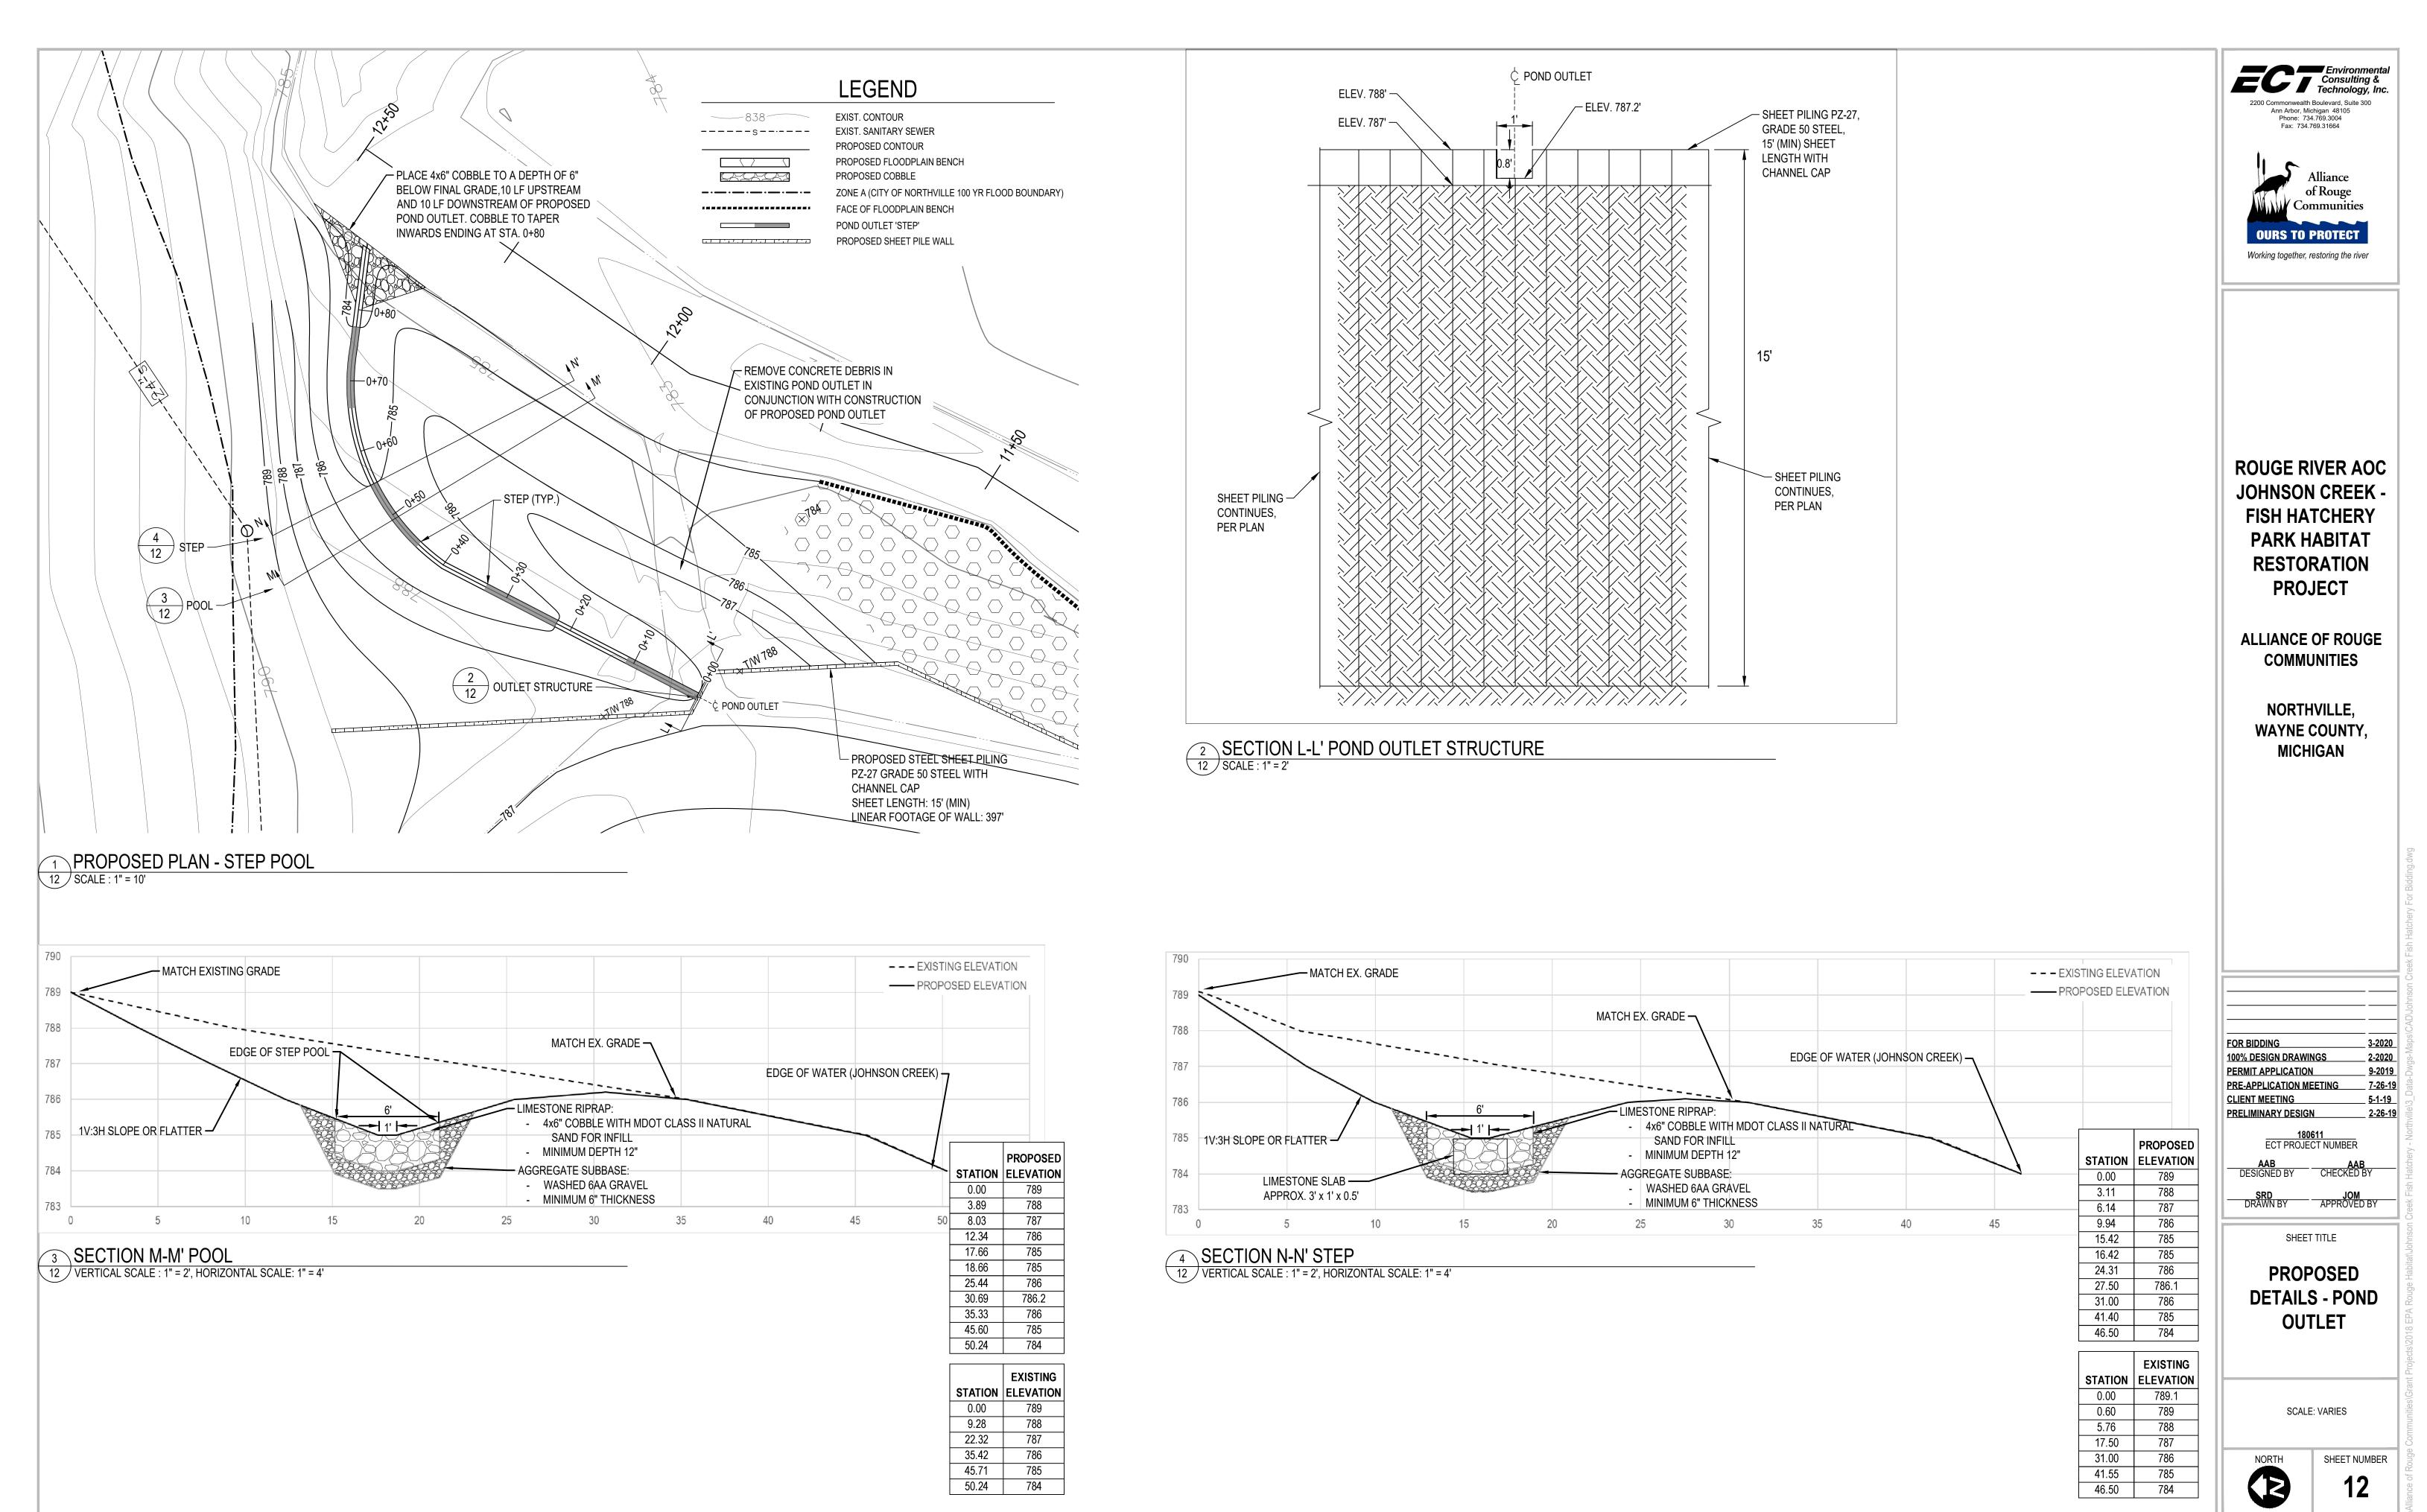
NORTHVILLE, **WAYNE COUNTY, MICHIGAN**


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PROPOSED CROSS **SECTIONS - POND**

SHEET TITLE





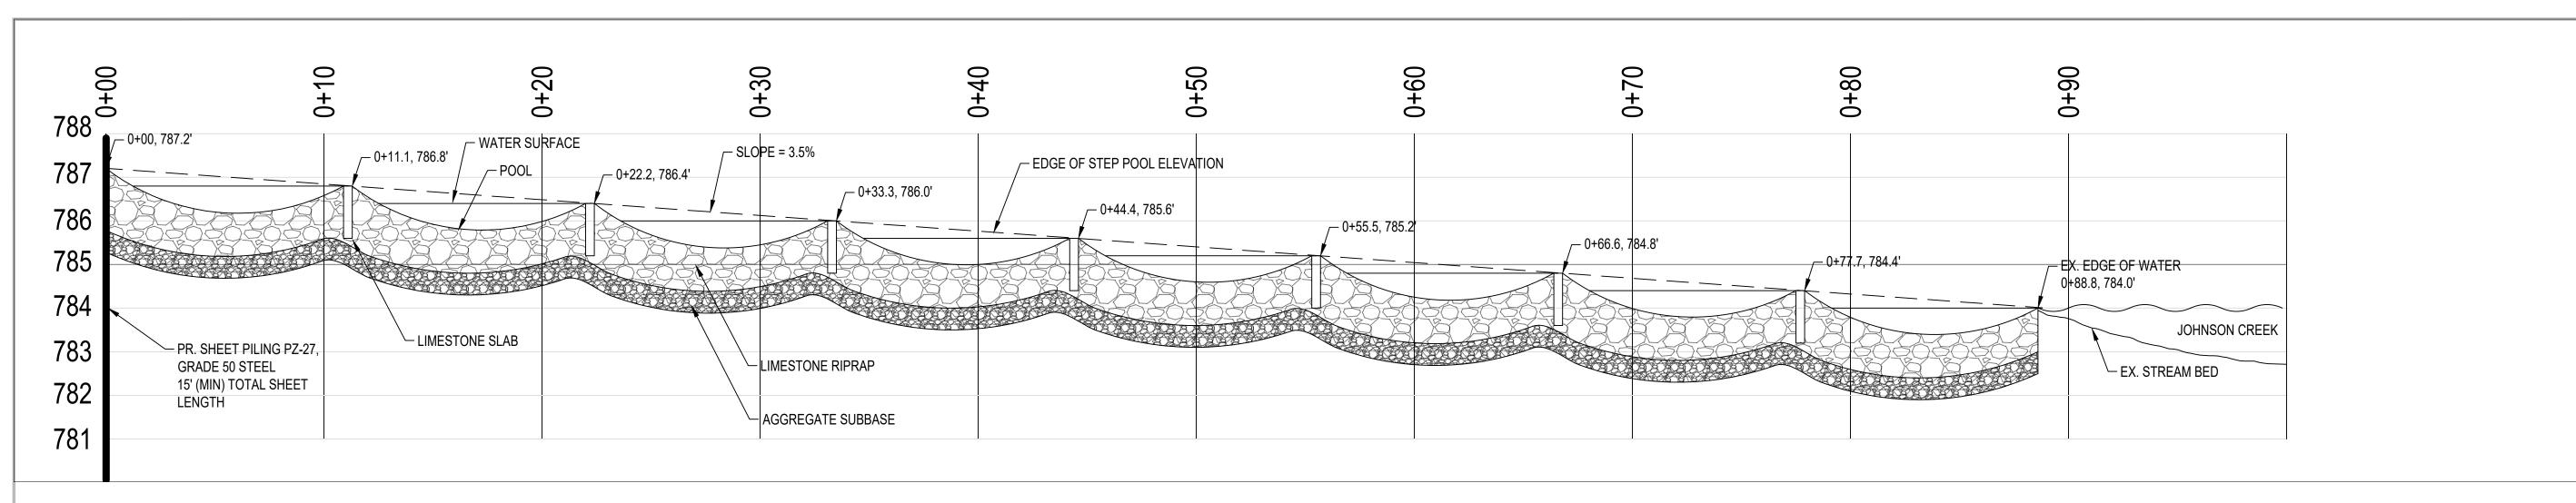


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1 STEP POOL PROFILE

13 VERTICAL SCALE : 1" = 0.5', HORIZONTAL SCALE: 1" = 4'



STEP POOL PROFILE DETAIL

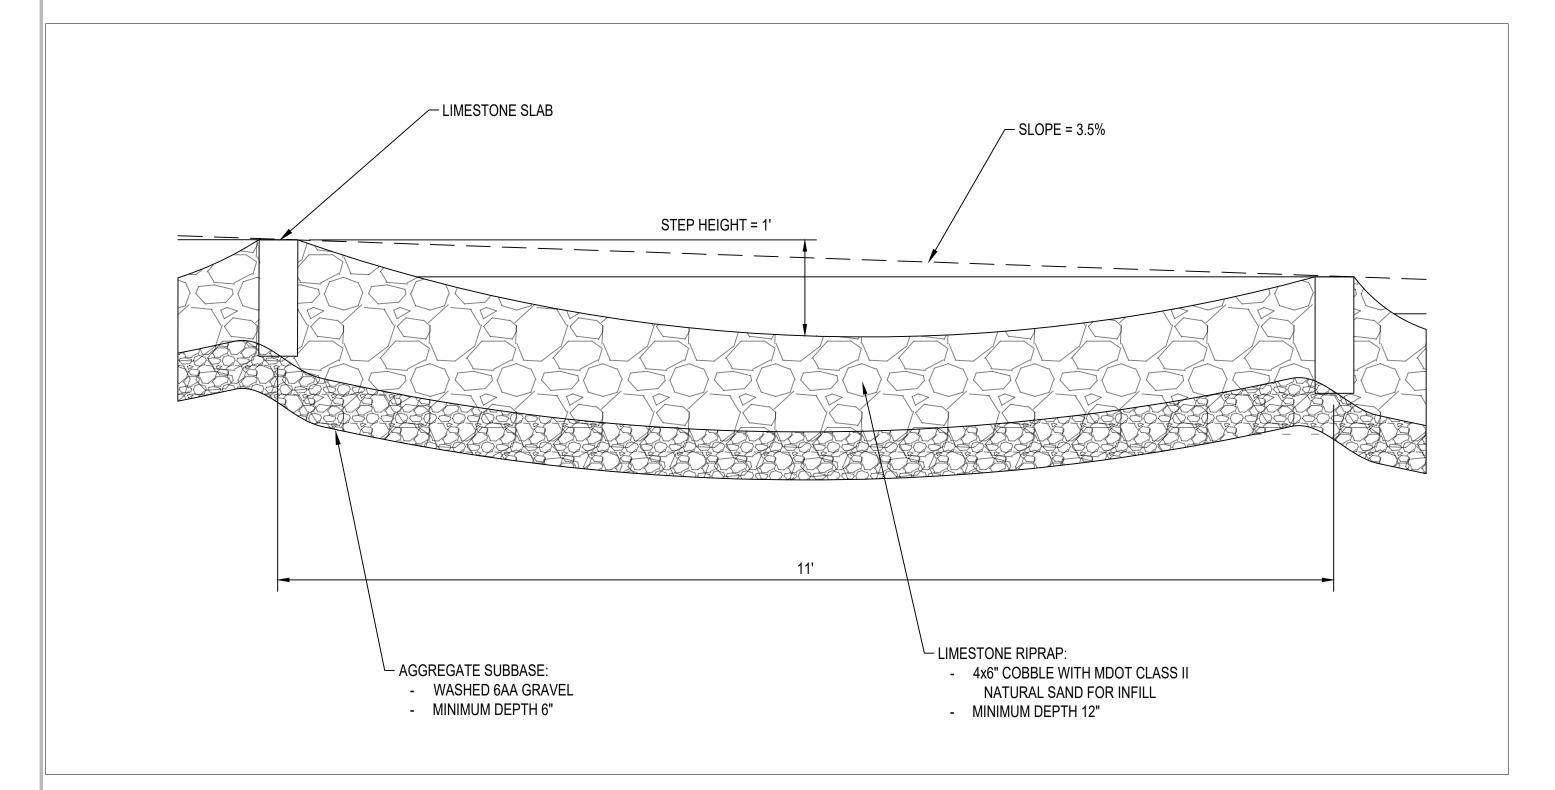SCALE: 1" = 2'

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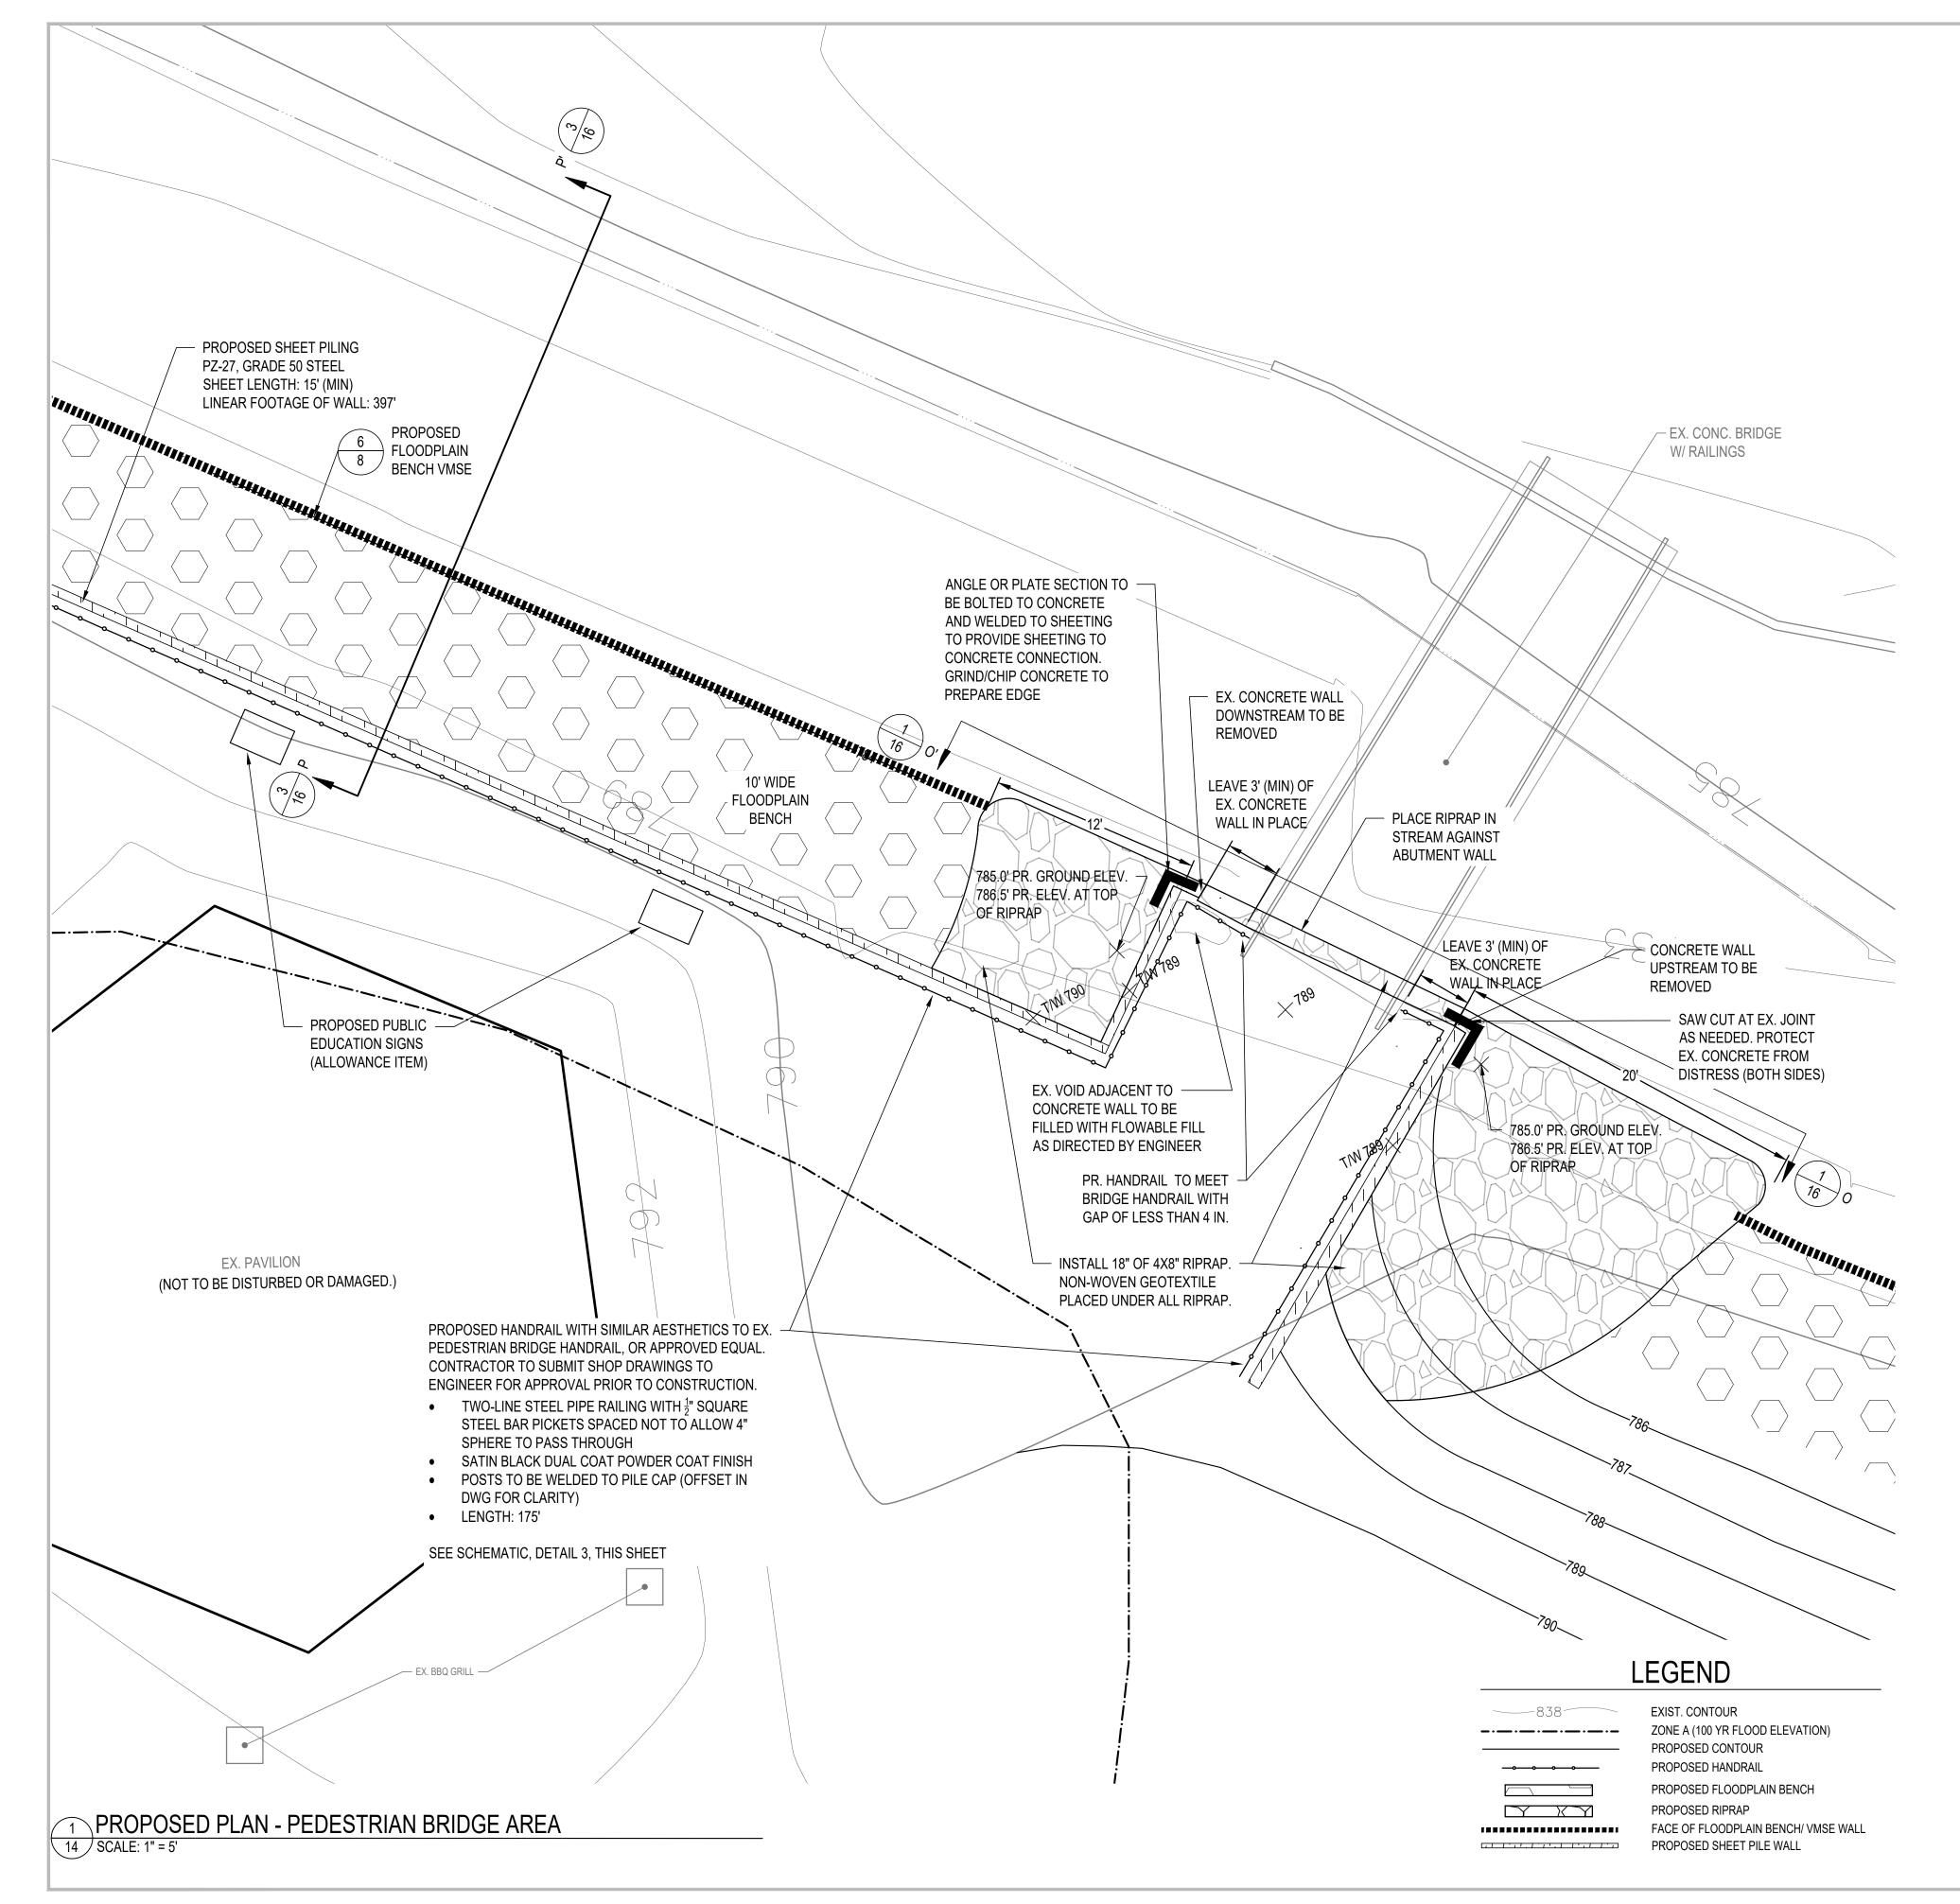
SHEET TITLE

PROPOSED PROFILE - POND OUTLET

SCALE: VARIES


SHEET NUMBER

13



SHEET PILE NOTIFICATION REQUIREMENT:

CONTRACTOR SHALL NOTIFY ENGINEER ONE WEEK PRIOR TO DRIVING SHEET PILE. CONTRACTOR SHALL PROVIDE ENGINEER WITH TENTATIVE DRIVING SCHEDULE AND CONFIRM SCHEDULE 48 HOURS PRIOR TO INSTALLATION OF SHEET PILES. CONTRACTOR SHALL PROVIDE ENGINEER WITH WEEKLY UPDATE ON DRIVING SCHEDULE UNTIL ALL SHEETING HAS BEEN INSTALLED.

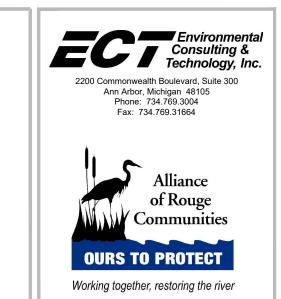

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AAB AAB


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SRD JOM


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SHEET TITLE

JOHNSON CREEK
PEDESTRIAN
BRIDGE





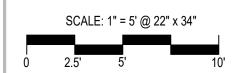

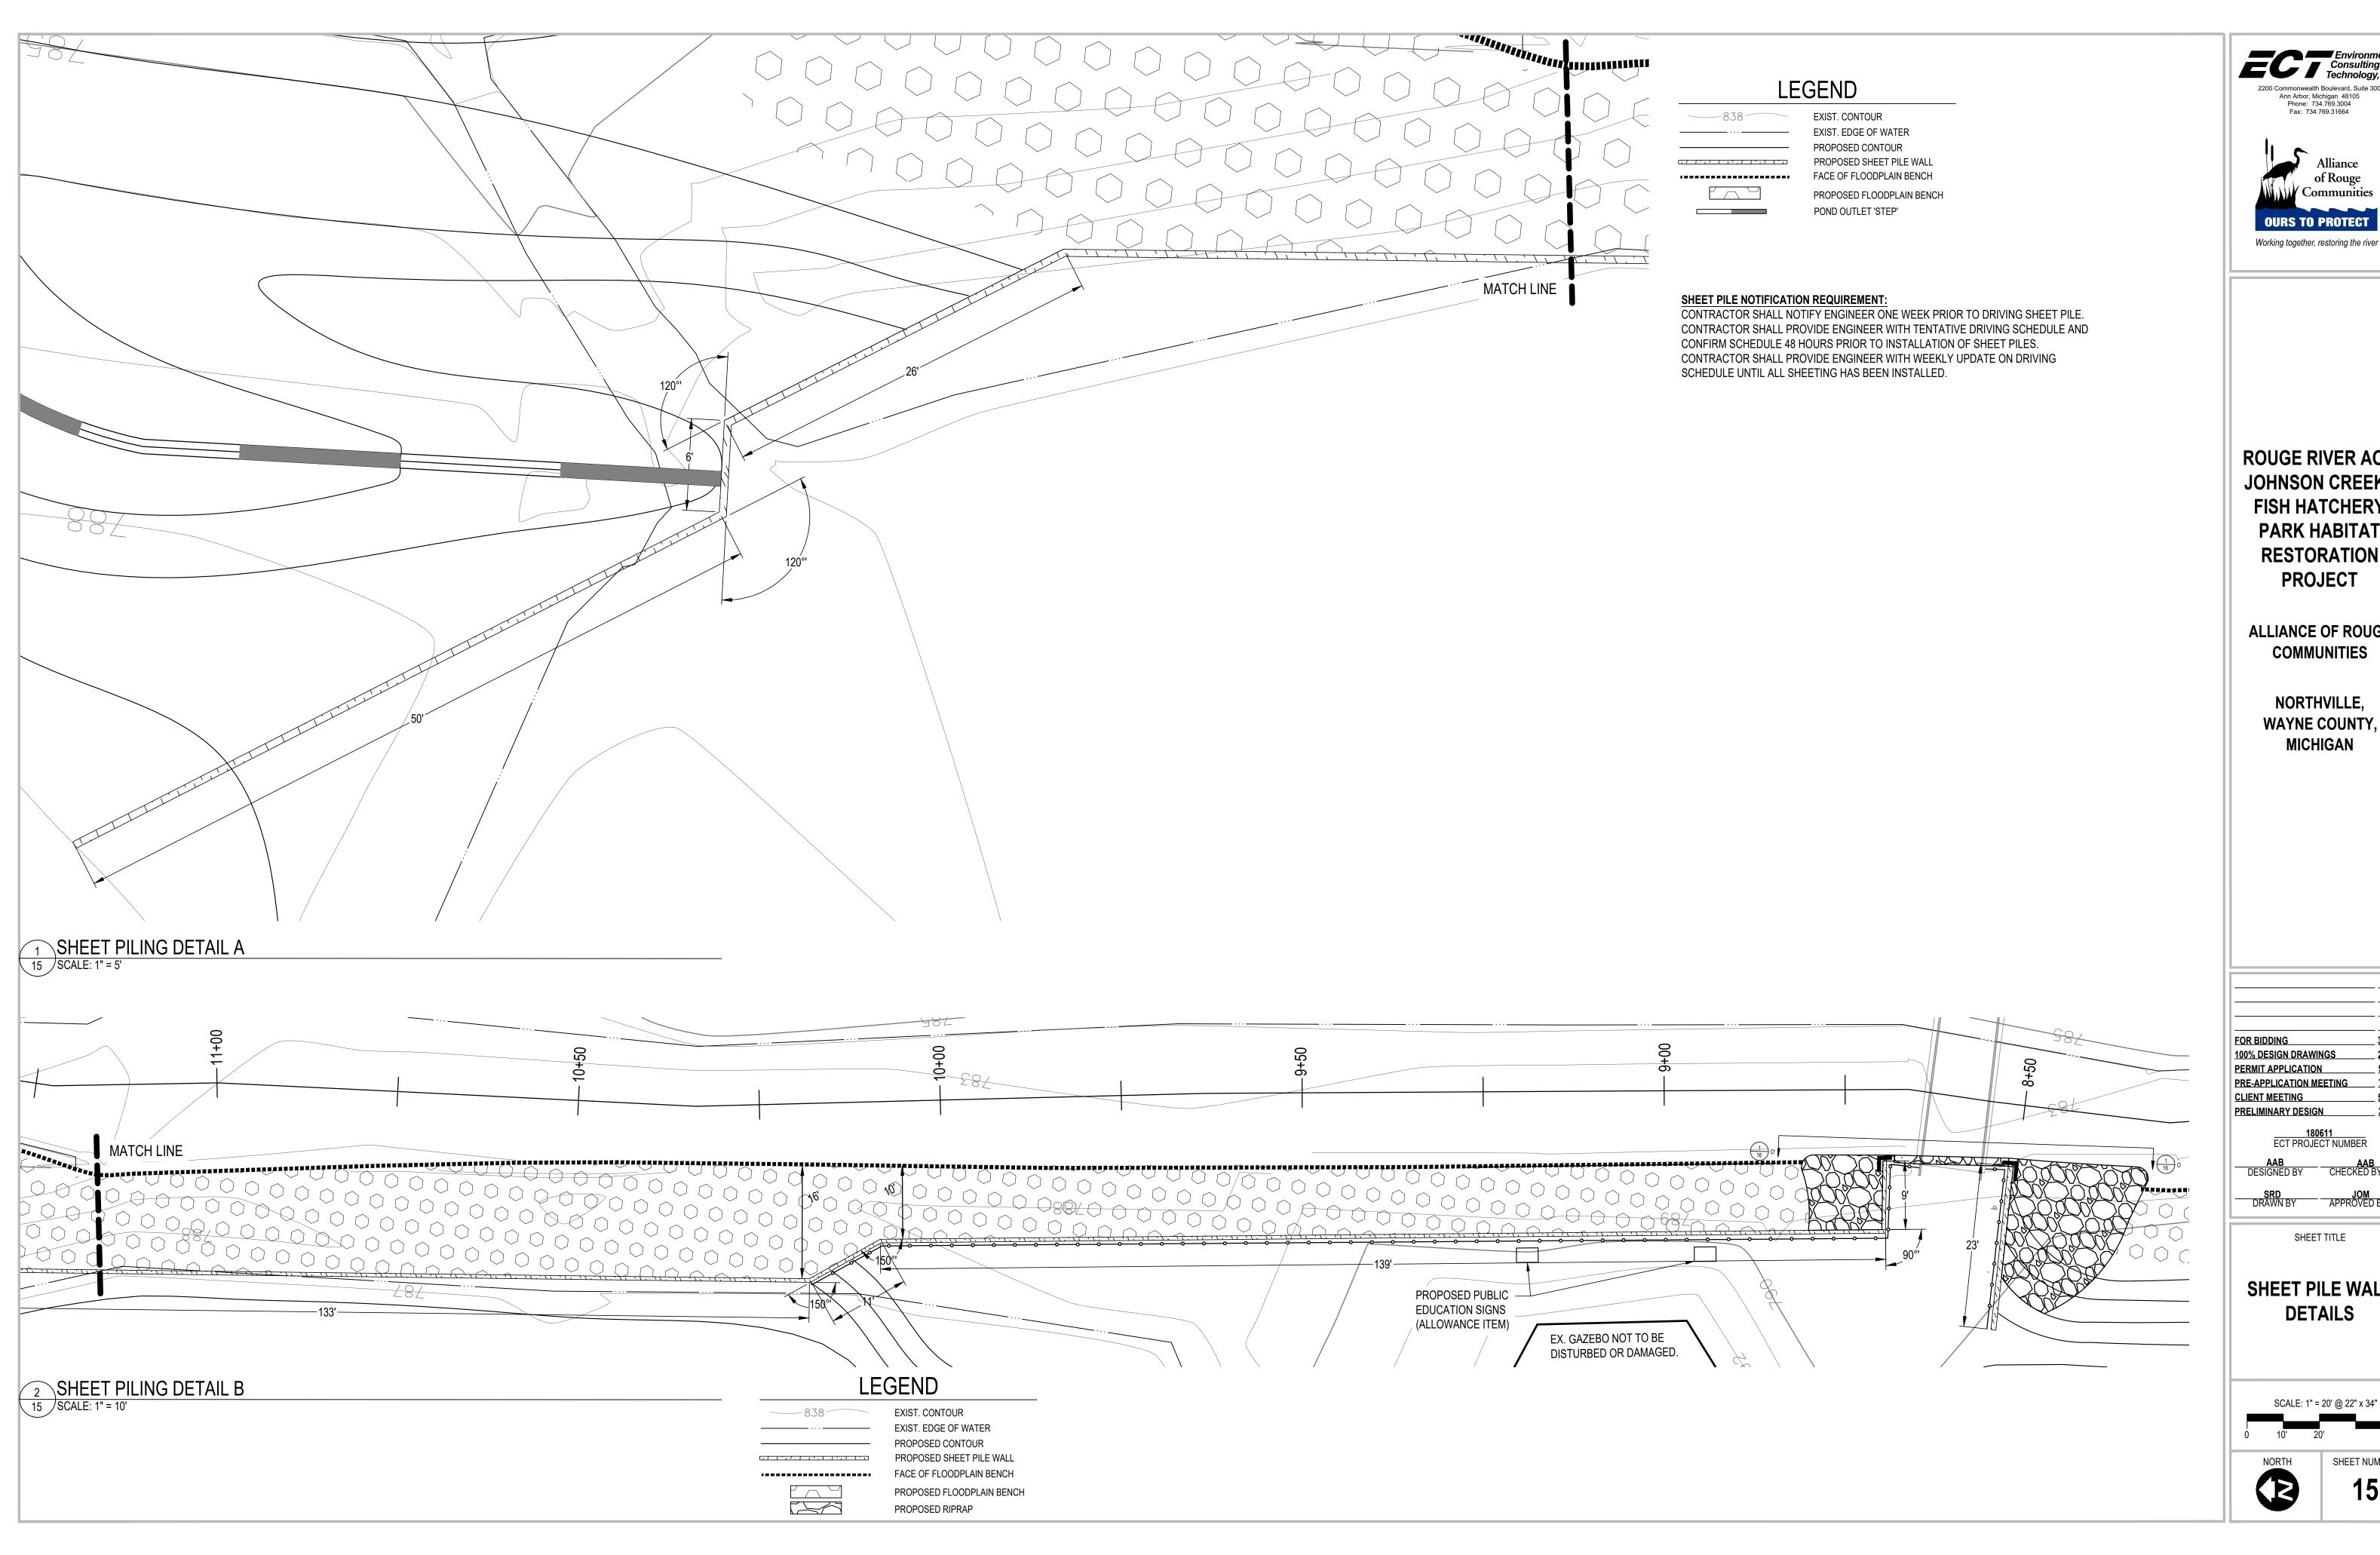2200 Commonwealth Boulevard, Suite 300 Ann Arbor, Michigan 48105 Phone: 734.769.3004 Fax: 734.769.31664



ROUGE RIVER AOC JOHNSON CREEK -FISH HATCHERY PARK HABITAT RESTORATION PROJECT


ALLIANCE OF ROUGE COMMUNITIES

NORTHVILLE, WAYNE COUNTY, **MICHIGAN**


PRE-APPLICATION MEETING <u>5-1-19</u> <u>2-26-19</u> 180611 ECT PROJECT NUMBER

SHEET TITLE

SHEET PILE WALL **DETAILS**

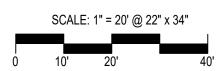



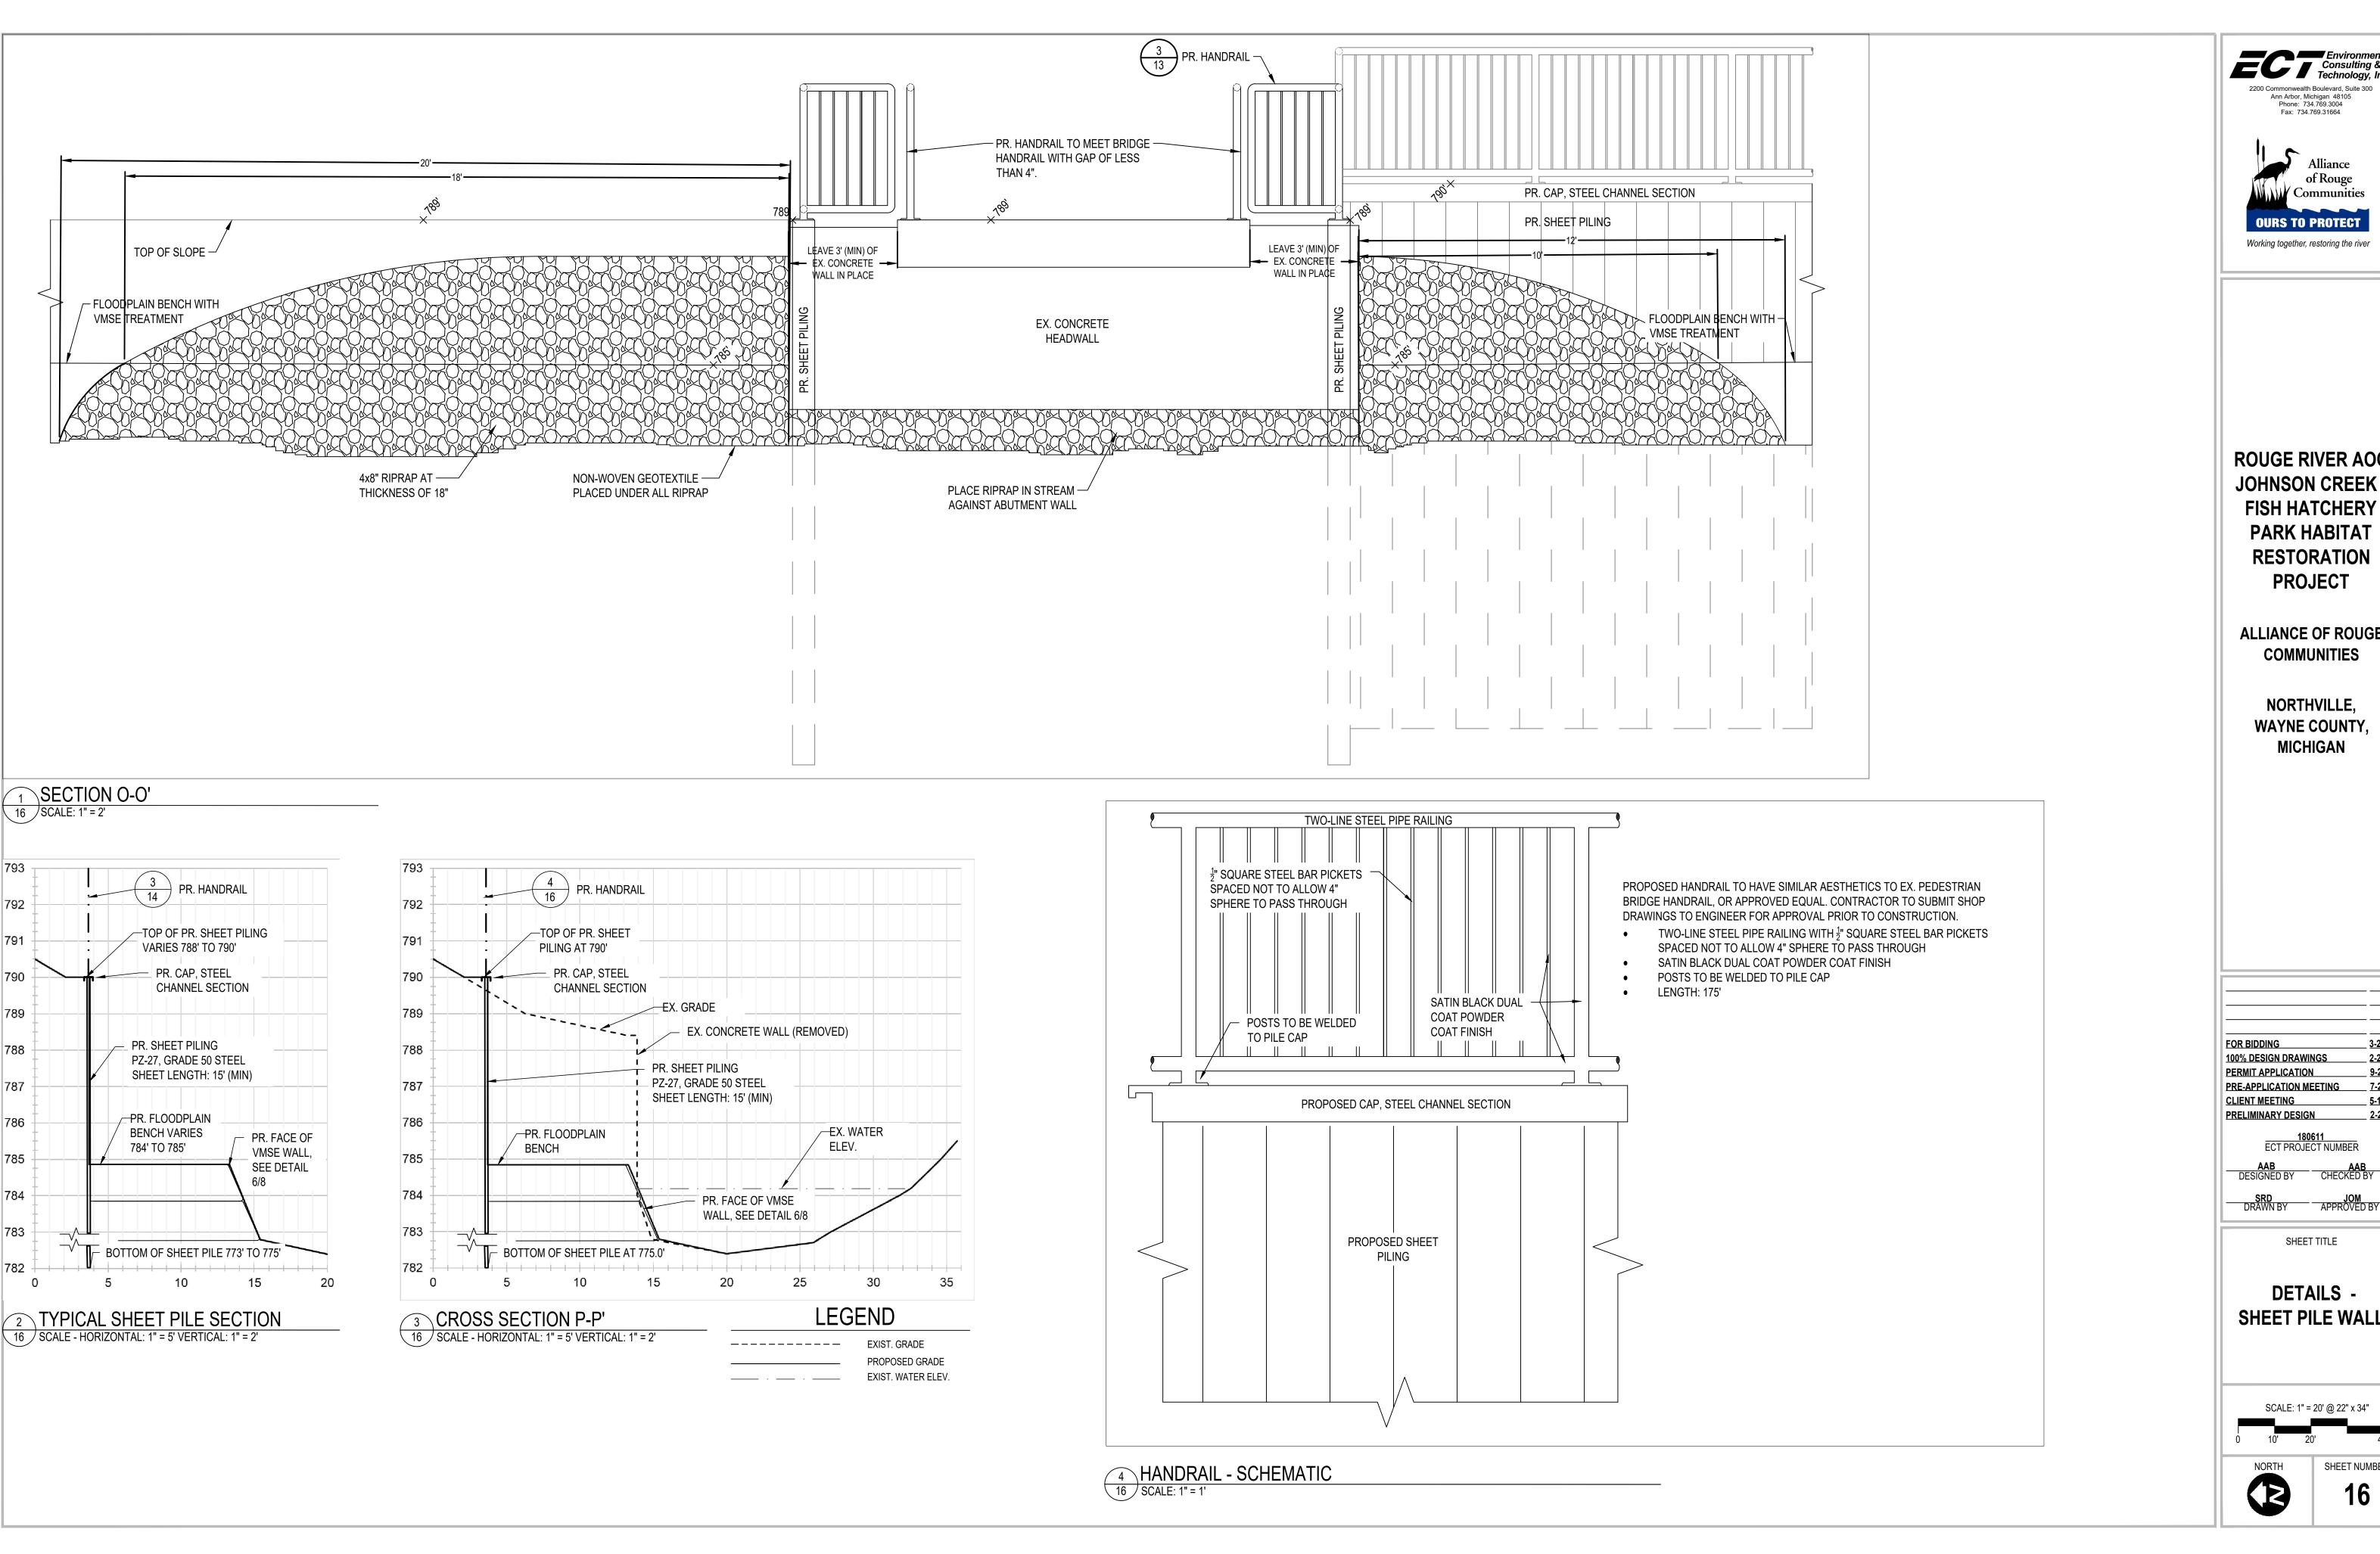

Ann Arbor, Michigan 48105 Phone: 734.769.3004 Fax: 734.769.31664 **OURS TO PROTECT**

> **ROUGE RIVER AOC** JOHNSON CREEK **FISH HATCHERY PARK HABITAT RESTORATION PROJECT**

ALLIANCE OF ROUGE COMMUNITIES

NORTHVILLE, WAYNE COUNTY, **MICHIGAN**


FOR BIDDING 100% DESIGN DRAWINGS <u>2-2020</u> PERMIT APPLICATION <u>9-2019</u> PRE-APPLICATION MEETING <u>7-26-19</u> **CLIENT MEETING** <u>5-1-19</u> PRELIMINARY DESIGN <u>2-26-19</u> 180611 ECT PROJECT NUMBER

DETAILS -SHEET PILE WALL

SHEET TITLE

SCALE: 1" = 20' @ 22" x 34"




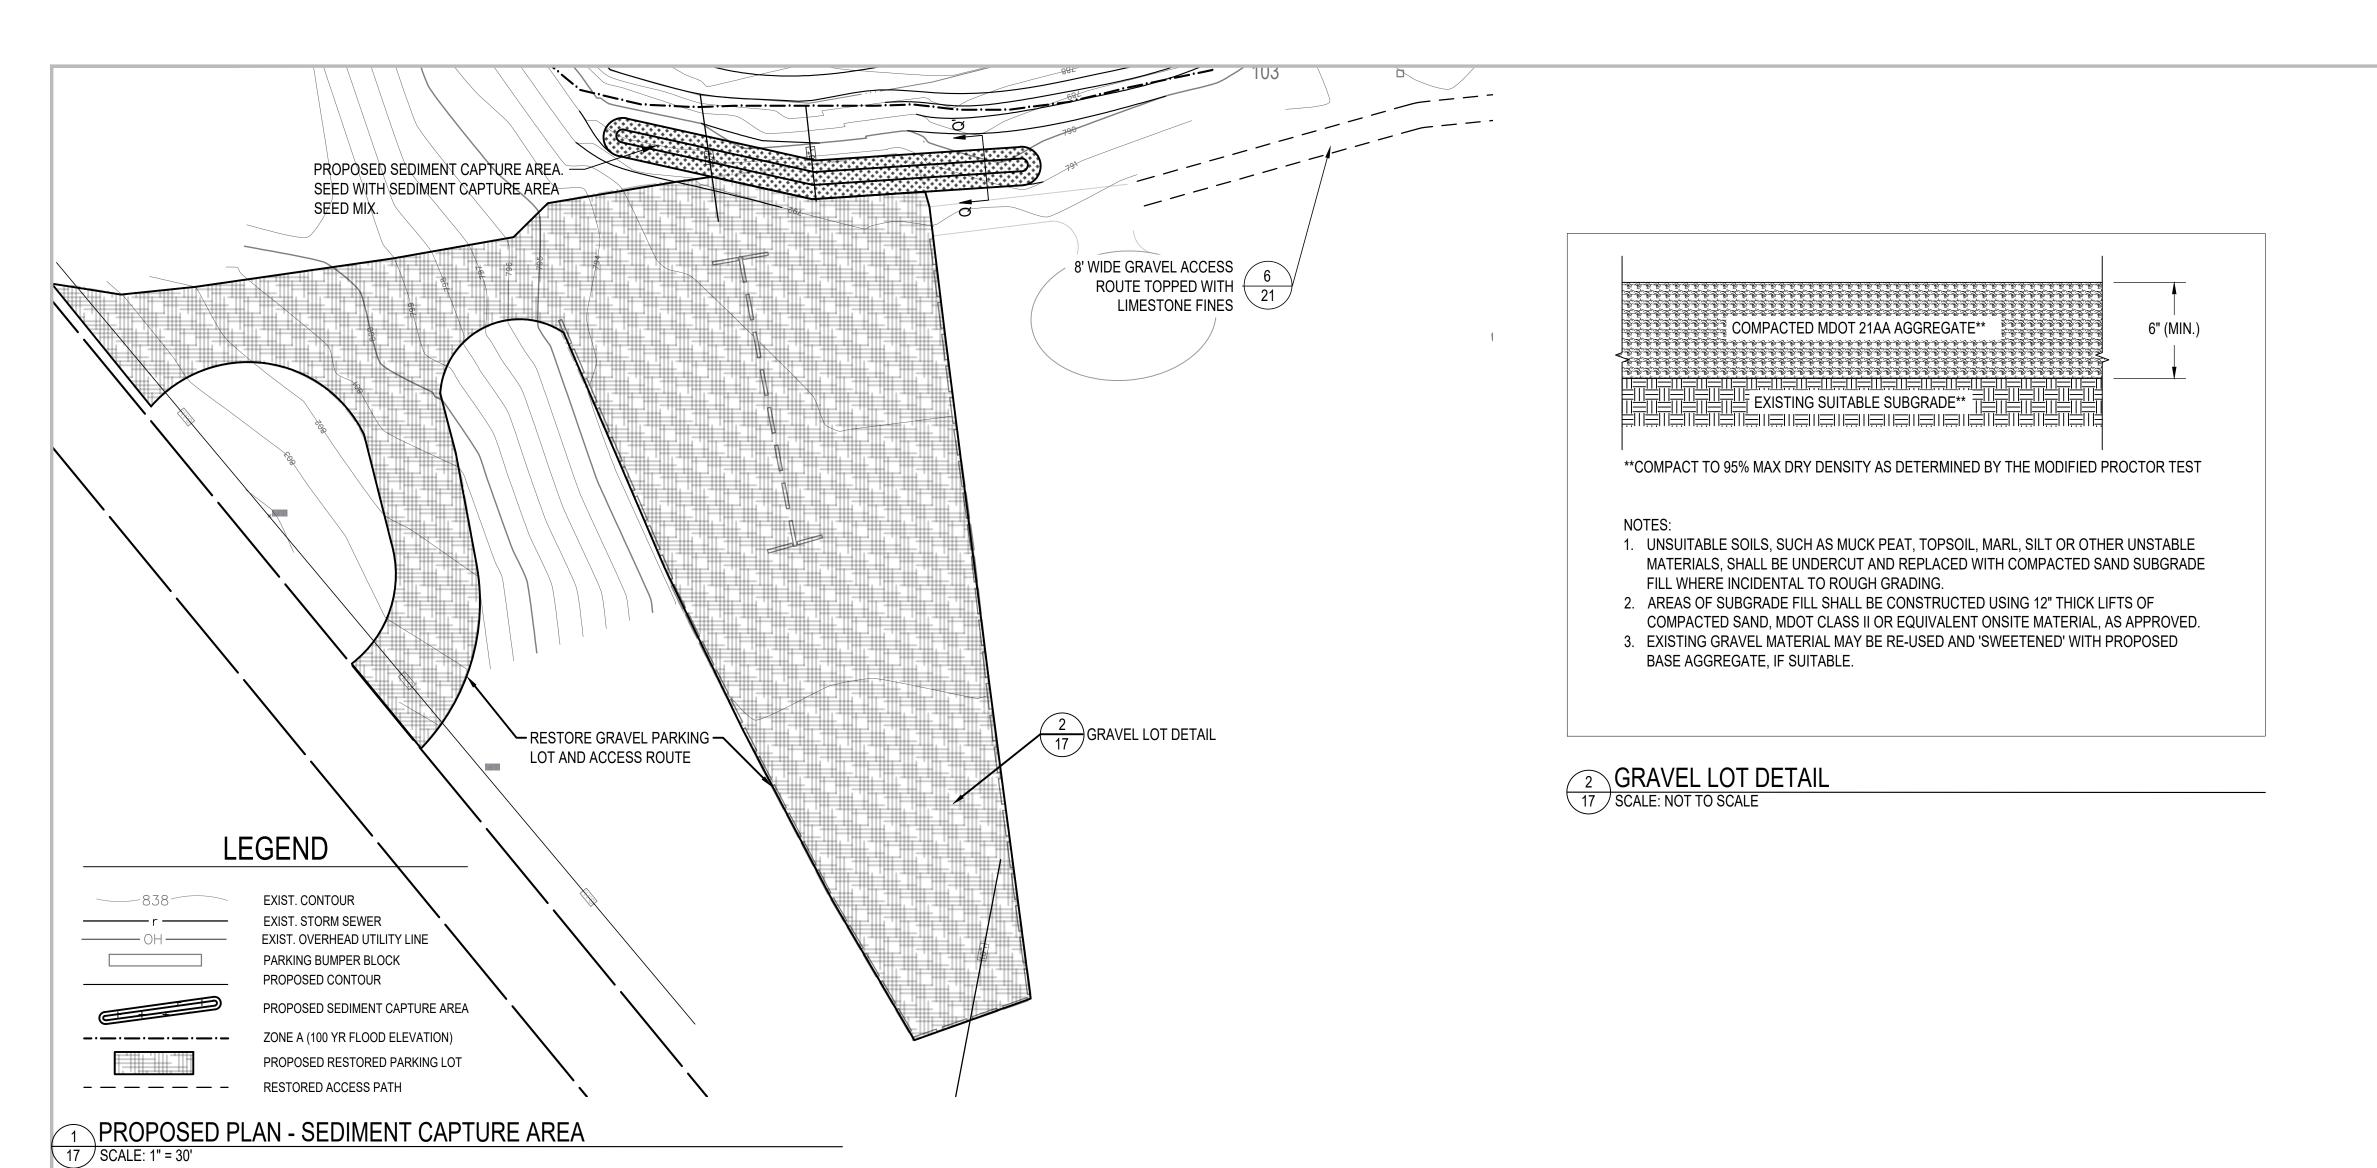

NOTE: 9' PIPES. DO NOT DISTURB.
CONTRACTOR TO PIELD VERRY
LOCATION AND ESCAPATION OF PIPES
UNCATION OF PIPES

3 SEDIMENT CAPTURE AREA - PLAN VIEW

17 SCALE: 1" = 8'

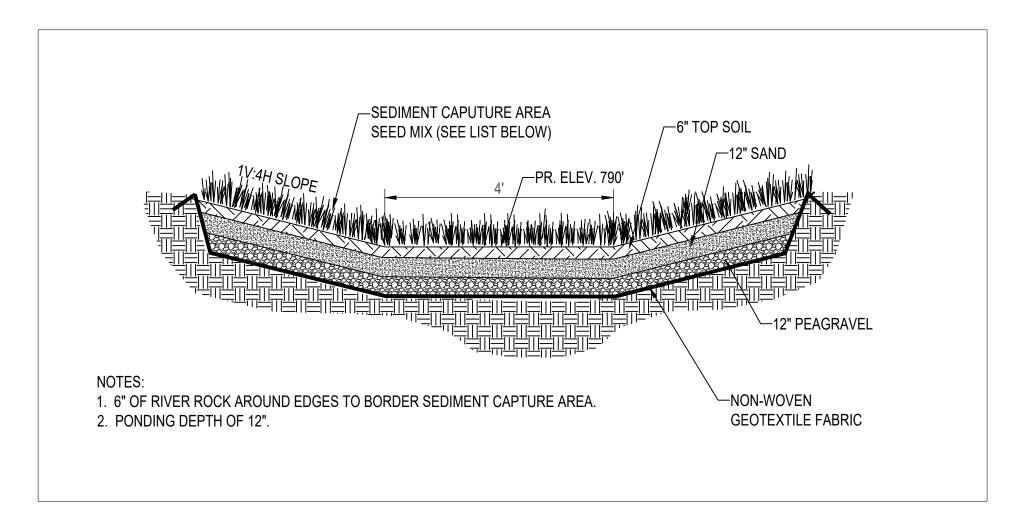

4 SECTION Q-Q' TYPICAL SEDIMENT CAPTURE AREA SECTION 17 SCALE: NOT TO SCALE

	SEDIMENT CAPTURE AREA SEED MI
--	-------------------------------

SCIENTIFIC NAME	COMMON NAME	OZ/AC
CAREX VULPINOIDEA	FOX SEDGE	25.00
ELYMUS CANADENSIS	CANADA WILD RYE	40.00
GLYCERIA STRIATA	FOWL MANNA GRASS	10.00
PANICUM VIRGATUM	SWITCH GRASS	12.00
SCHOENOPLECTUS ACUTUS	HARDSTEM BULRUSH	12.00
SCHOENOPLECTUS PUNGENS	THREE-SQUARE BULRUSH	12.00
TOTAL		111.00
AVENA SATIVA	SEED OATS	320.0

Environmental Consulting & Technology, Inc.

2200 Commonwealth Boulevard, Suite 300
Ann Arbor, Michigan 48105
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Fax: 734.769.31664

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ROUGE RIVER AOC
JOHNSON CREEK FISH HATCHERY
PARK HABITAT
RESTORATION
PROJECT


ALLIANCE OF ROUGE COMMUNITIES

NORTHVILLE, WAYNE COUNTY, MICHIGAN

> SEDIMENT CAPTURE AREA

> > SCALE: VARIES

NORTH

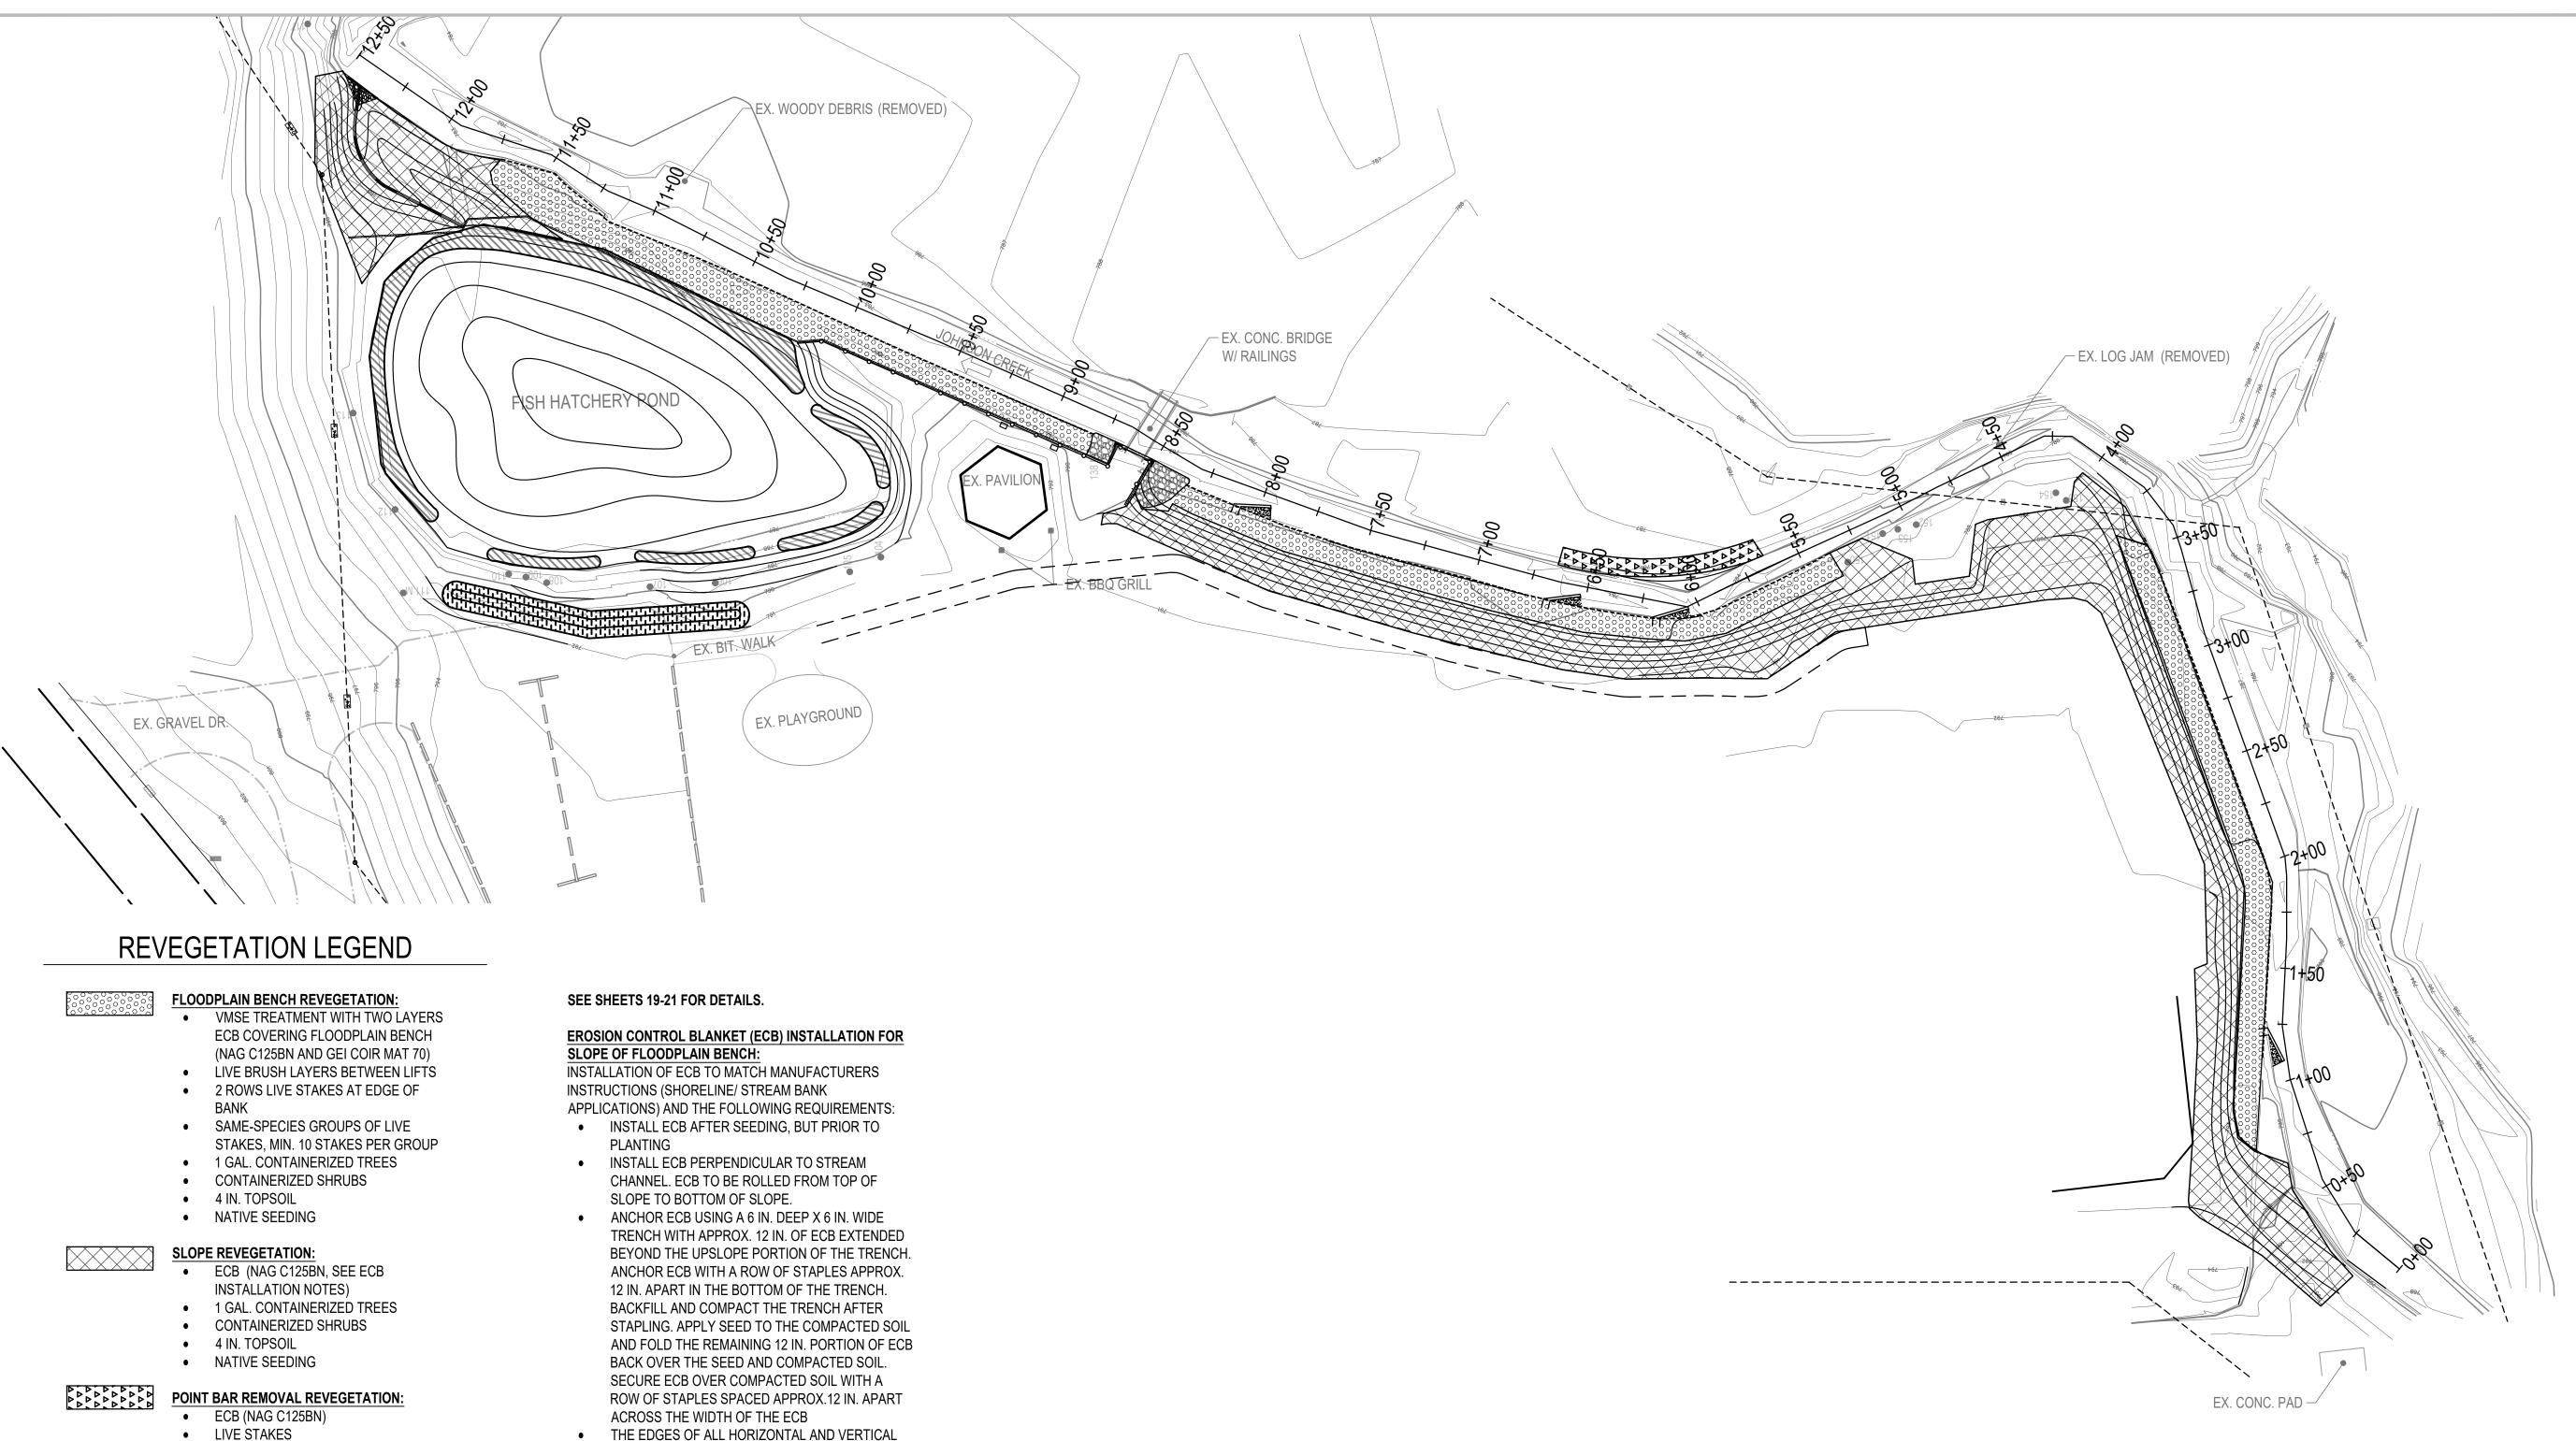

THE EDGES OF ALL HORIZONTAL AND VERTICAL

SEAMS MUST BE STAPLED WITH A 2 IN. TO 5 IN.

USED TO SECURE ECB. STAPLE PATTERN MUST

MATCH "STAPLE PATTERN D" WITH MIN. STAPLE

DENSITY OF 3.4 STAPLES PER SQUARE YARD.

IN THE STREAM FLOW DIRECTION.

AN ADEQUATE NUMBER OF STAPLES MUST BE

OVERLAP. SEAM OVERLAPS SHOULD BE SHINGLED

4 IN. TOPSOIL

NATIVE SEEDING

• ECB (NAG S75BN) • 6 IN. TOPSOIL

NATIVE SEEDING

EMERGENT PLANTINGS

ALL OTHER DISTURBED AREA:


POND REVEGETATION:

4 IN. TOPSOIL

TURF SEEDING

SEDIMENT CAPTURE AREA REVEGETATION:

 ECB (NAG S75BN), HYDROSEEDING, OR BLOWN AND CRIMPED STRAW

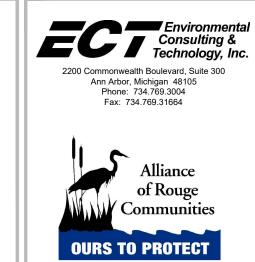

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ROUGE RIVER AOC JOHNSON CREEK **FISH HATCHERY PARK HABITAT RESTORATION PROJECT**

ALLIANCE OF ROUGE COMMUNITIES


NORTHVILLE, WAYNE COUNTY, **MICHIGAN**


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REVEGETATION PLAN - OVERVIEW





TREES	s⊕				
SYM	QTY	SCIENTIFIC NAME	COMMON NAME	SIZE	CONT.
AR	5	ACER RUBRUM	RED MAPLE	2.5" CAL.	B&B
ar	17	ACER RUBRUM	RED MAPLE	N/A	1 GAL.
AS	1	ACER SACCHARINUM	SILVER MAPLE	2.5" CAL.	B&B
as	9	ACER SACCHARINUM	SILVER MAPLE	N/A	1 GAL.
CO	9	CELTIS OCCIDENTALIS	NORTHERN HACKBERRY	2.5" CAL.	B&B
СО	7	CELTIS OCCIDENTALIS	NORTHERN HACKBERRY	N/A	1 GAL.
LT	6	LIRIODENDRON TULIPIFERA	TULIP POPLAR	2.5" CAL.	B&B
lt	9	LIRIODENDRON TULIPIFERA	TULIP POPLAR	N/A	1 GAL.
QB	10	QUERCUS BICOLOR	SWAMP WHITE OAK	2.5" CAL.	B&B
qb	10	QUERCUS BICOLOR	SWAMP WHITE OAK	N/A	1 GAL.
PL	4	PLATANUS OCCIDENTALIS	AMERICAN SYCAMORE	2.5" CAL.	B&B
pl	9	PLATANUS OCCIDENTALIS	AMERICAN SYCAMORE	N/A	1 GAL.

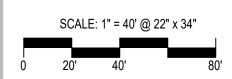SHRUBS ⊕						
	SYM	QTY	SCIENTIFIC NAME	COMMON NAME	SIZE	CON.
	CE	28	CEPHALANTHUS OCCIENTALIS	BUTTONBUSH	36" HT.	3 GA
	SC	32	SAMBUCUS CANADENSIS	AMERICAN ELDER	36" HT.	3 GA
	LB	118	LINDERA BENZOIN	SPICEBUSH	36" HT.	3 G/
	IV	32	ILEX VERTICILLATA	MICHIGAN HOLLY	36" HT.	3 GA

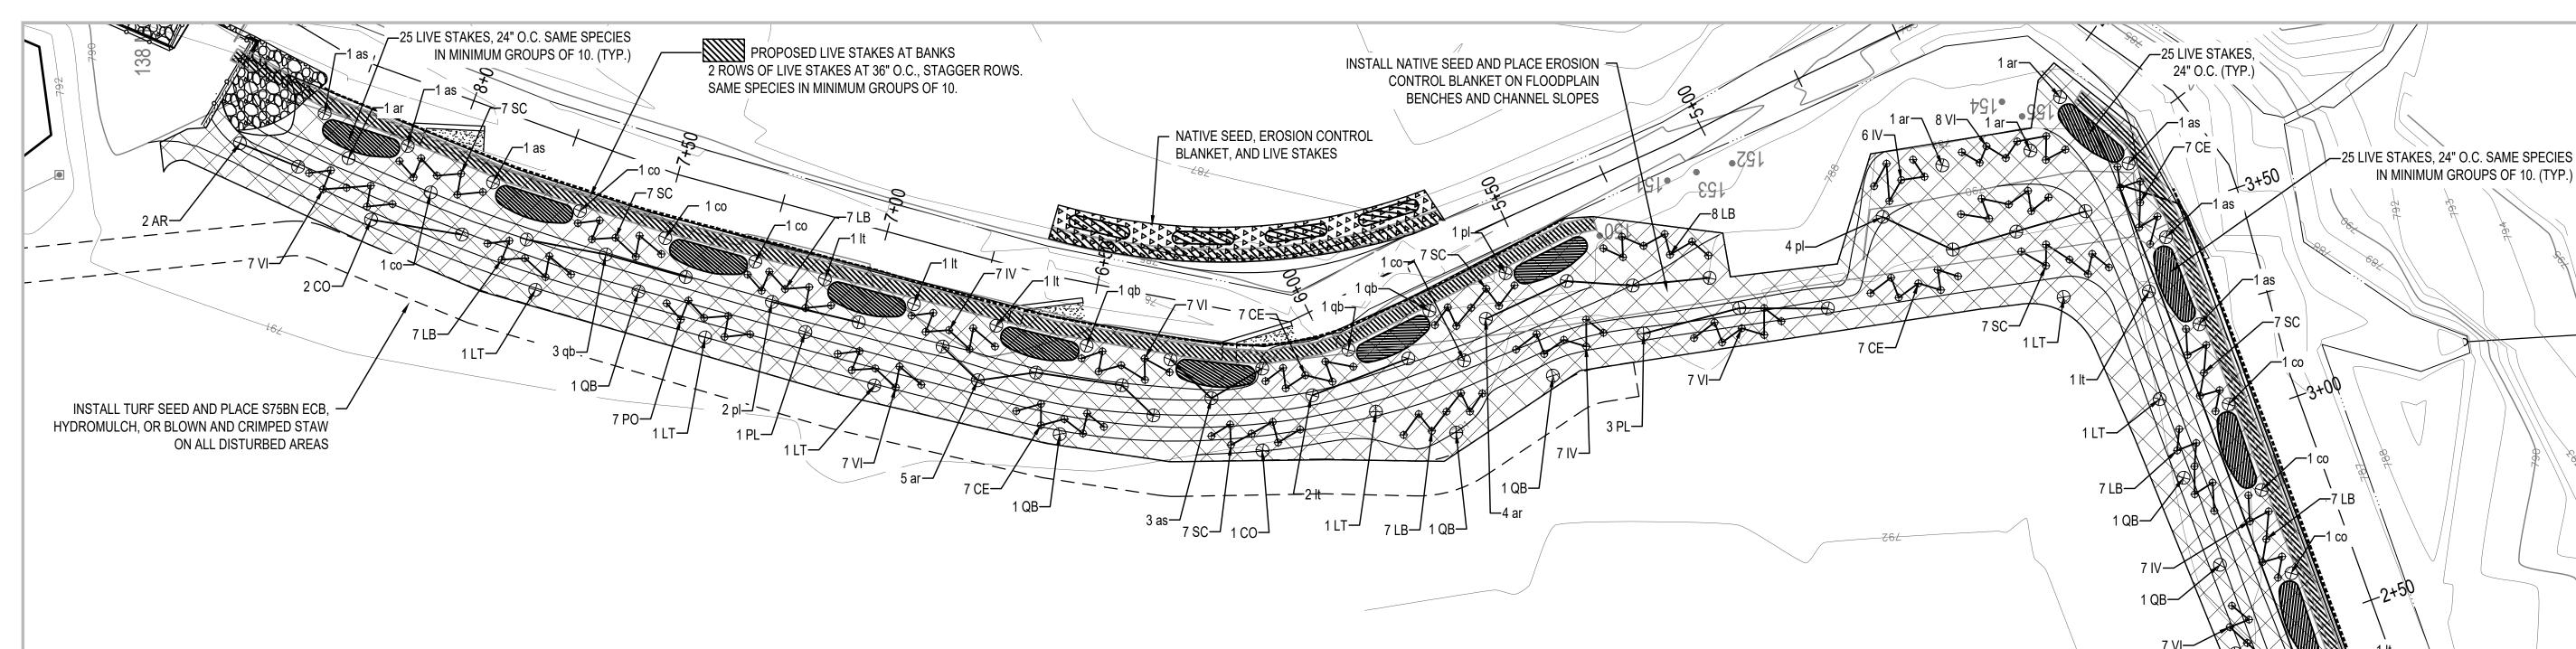NANNYBERRY

36" HT.

LIVE STAKE SPECIES LIST	T (760 TOTAL):	
SCIENTIFIC NAME	COMMON NAME	
CORNUS SERICEA	RED-OSIER DOGW	OOD
CORNUS AMOMUM	SILKY DOGWOOD	
SALIX EXIGUA	SANDBAR WILLOW	I
SALIX DISCOLOR	PUSSY WILLOW	
SALIX SERICEA	SILKY WILLOW	
SALIX NIGRA	BLACK WILLOW	
SALIX AMYGDALOIDES	PEACH-LEAF WILL	OW

LISTED SPECIES ARE TO BE EQUALLY REPRESENTED.

VI 92 VIBURNUM TRILOBUM

COMMON NAME
RED-OSIER DOGWOOD
SILKY DOGWOOD
SANDBAR WILLOW
PUSSY WILLOW
SILKY WILLOW
BLACK WILLOW
PEACH-LEAF WILLOW

LISTED SPECIES ARE TO BE EQUALLY REPRESENTED.

BRUSH LAYER SIZES: 5 LF (MINIMUM) PER BUNDLE, 3-4 BRANCHES THICK.

INSTALLATION NOTES: LIVE BRUSH LAYERS TO BE PLACED BETWEEN ENCAPSULATED SOIL LIFTS IN FLOODPLAIN BENCHES WITH TWO-THIRDS OF THE BASAL MATERIAL TILTED INTO THE SLOPE AND COVERED WITH SOIL. BRANCHES SHOULD PROTRUDE BEYOND THE FACE OF THE TERRACE. STARTING WITH THE FIRST SOIL LIFT ABOVE THE WATER ELEVATION AT THE TIME OF CONSTRUCTION, ADDITIONAL LIVE BRUSH LAYERS SHOULD BE ADDED BETWEEN EVERY SOIL LIFT PROCEEDING UP THE FACE OF THE STREAM BANK. PLANTING SHOULD BE DONE DURING THE DORMANT SEASON.

WET TO MESIC SEED MIX		
SCIENTIFIC NAME	COMMON NAME	OZ/AC
GRASSES/SEDGES		
ANDROPOGON GERARDII	BIG BLUESTEM GRASS	16.00
CALAMAGROSTIS CANADENSIS	BLUEJOINT GRASS	1.000
CAREX LURIDA	BOTTLEBRUSH SEDGE	3.000
CAREX STRICTA	COMMON TUSSOCK SEDGE	1.000
CAREX VULPINOIDEA	BROWN FOX SEDGE	1.000
ELYMUS HYSTRIX	BOTTLEBRUSH GRASS	1.000
ELYMUS VIRGINICUS	VIRGINIA WILD RYE	24.00
JUNCUS CANADENSIS	CANADIAN RUSH	0.500
JUNCUS EFFUSUS	SOFT RUSH	1.000
PANICUM VIRGATUM	SWITCH GRASS	2.000
SCIRPUS CYPERINUS	WOOL GRASS	0.500
SORGHASTRUM NUTANS	INDIAN GRASS	8.000
SPARTINA PECTINATA	PRAIRIE CORD GRASS	3.000
FORBS		
ASCLEPIAS SYRIACA	COMMON MILKWEED	2.000
ASCLEPIAS INCARNATA	SWAMP MILKWEED	2.000
COREOPSIS LANCEOLATA	SAND COREOPSIS	4.000
COREOPSIS TRIPTERIS	TALL COREOPSIS	2.000
DOELLINGERIA UMBELLATA	FLAT TOPPED ASTER	0.500
ECHINACEA PURPUREA	PURPLE CONEFLOWER	4.000
EUPATORIUM MACULATUM	JOE PYE WEED	1.000
EUPATORIUM PERFOLIATUM	COMMON BONESET	0.500
HELENIUM AUTUMNALE	SNEEZEWEED	2.000
IRIS VIRGINICA	BLUE FLAG IRIS	2.000
LIATRIS SPICATA	MARSH BLAZING STAR	1.000
LOBELIA CARDINALIS	CARDINAL FLOWER	0.250
LOBELIA SIPHILITICA	GREAT BLUE LOBELIA	2.000
PHYSOSTEGIA VIRGINIANA	OBEDIENT PLANT	0.250
PYCNANTHEMUM VIRGINIANUM	COMMON MOUNTAIN MINT	0.500
RUDBECKIA LACINATA	GREEN CONEFLOWER	1.000
RATIBIDA PINNATA	YELLOW CONEFLOWER	4.000
RUDBECKIA HIRTA	BLACK-EYED SUSAN	4.000
RUDBECKIA LACINIATA	WILD GOLDEN GLOW	1.000
SOLIDAGO JUNCEA	EARLY GOLDENROD	0.250
SOLIDAGO JUNCEA SOLIDAGO RUGOSA	ROUGH GOLDENROD	0.250
SYMPHYOTRICHUM NOVAE-ANGLIAE	NEW ENGLAND ASTER	0.500
SYMPHYOTRICHUM NOVAE-ANGLIAE SYMPHYOTRICHUM PUNICEUM	BRISTLY ASTER	1.000
VERONIA MISSURICA	IRONWEED	3.000
	GOLDEN ALEXANDERS	
ZIZIA AUREA		0.250
COVER CROP	TOTAL	100.25
COVER CROP		500 O
AVENA SATIVA	COMMON OAT	500.0

REVEGETATION LEGEND

FLOODPLAIN BENCH REVEGETATION:

- VMSE TREATMENT WITH TWO LAYERS ECB COVERING FLOODPLAIN BENCH (NAG C125BN AND GEI COIR MAT 70)
- LIVE BRUSH LAYERS BETWEEN LIFTS 2 ROWS LIVE STAKES AT EDGE OF
- SAME-SPECIES GROUPS OF LIVE STAKES, MIN. 10 STAKES PER GROUP
- 1 GAL. CONTAINERIZED TREES
- CONTAINERIZED SHRUBS
- 4 IN. TOPSOIL
- NATIVE SEEDING

SLOPE REVEGETATION:

- ECB (NAG C125BN, SEE ECB
- INSTALLATION NOTES) 1 GAL. CONTAINERIZED TREES
- CONTAINERIZED SHRUBS
- 4 IN. TOPSOIL
- NATIVE SEEDING

POINT BAR REMOVAL REVEGETATION:

- ECB (NAG C125BN)
- LIVE STAKES 4 IN. TOPSOIL
- NATIVE SEEDING

SEDIMENT CAPTURE AREA REVEGETATION:


- ECB (NAG S75BN)
- 6 IN. TOPSOIL NATIVE SEEDING

POND REVEGETATION:

EMERGENT PLANTINGS

ALL OTHER DISTURBED AREA:

- ECB (NAG S75BN), HYDROSEEDING,
- OR BLOWN AND CRIMPED STRAW
- 4 IN. TOPSOIL TURF SEEDING

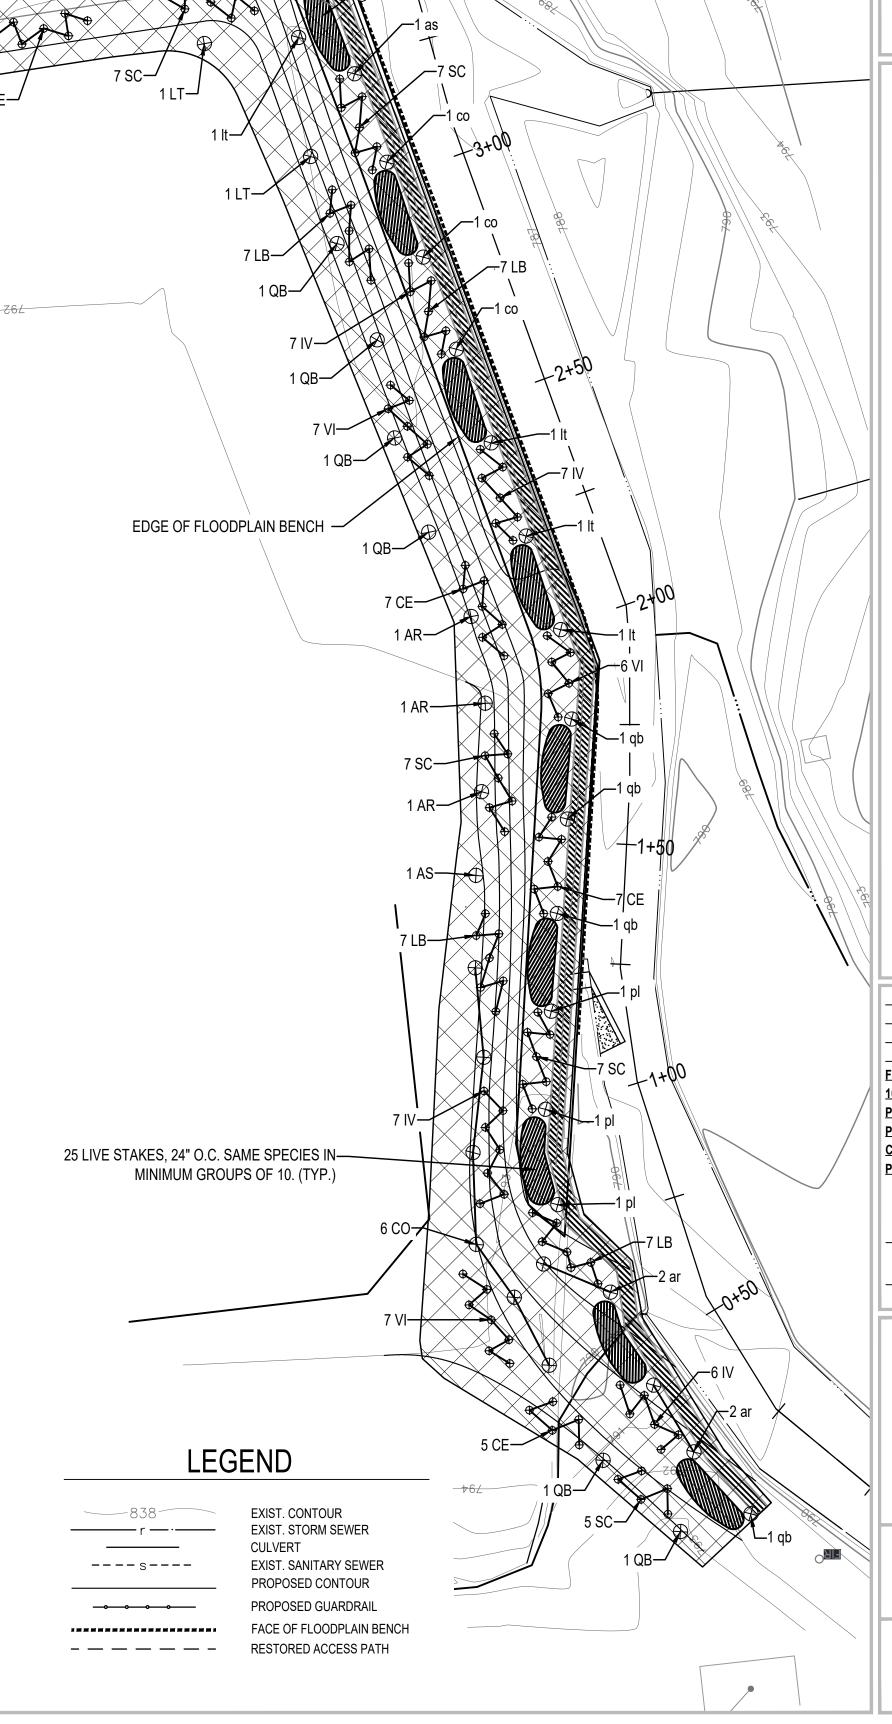

ROUGE RIVER AOC JOHNSON CREEK FISH HATCHERY PARK HABITAT RESTORATION PROJECT

2200 Commonwealth Boulevard, Suite 300

Ann Arbor, Michigan 48105 Phone: 734.769.3004 Fax: 734.769.31664

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ALLIANCE OF ROUGE COMMUNITIES

NORTHVILLE, WAYNE COUNTY, **MICHIGAN**

FOR BIDDING 100% DESIGN DRAWINGS 2-2020 PERMIT APPLICATION <u>9-2019</u> PRE-APPLICATION MEETING <u>7-26-19</u> CLIENT MEETING <u>5-1-19</u> PRELIMINARY DESIGN <u>2-26-19</u> 180611 ECT PROJECT NUMBER

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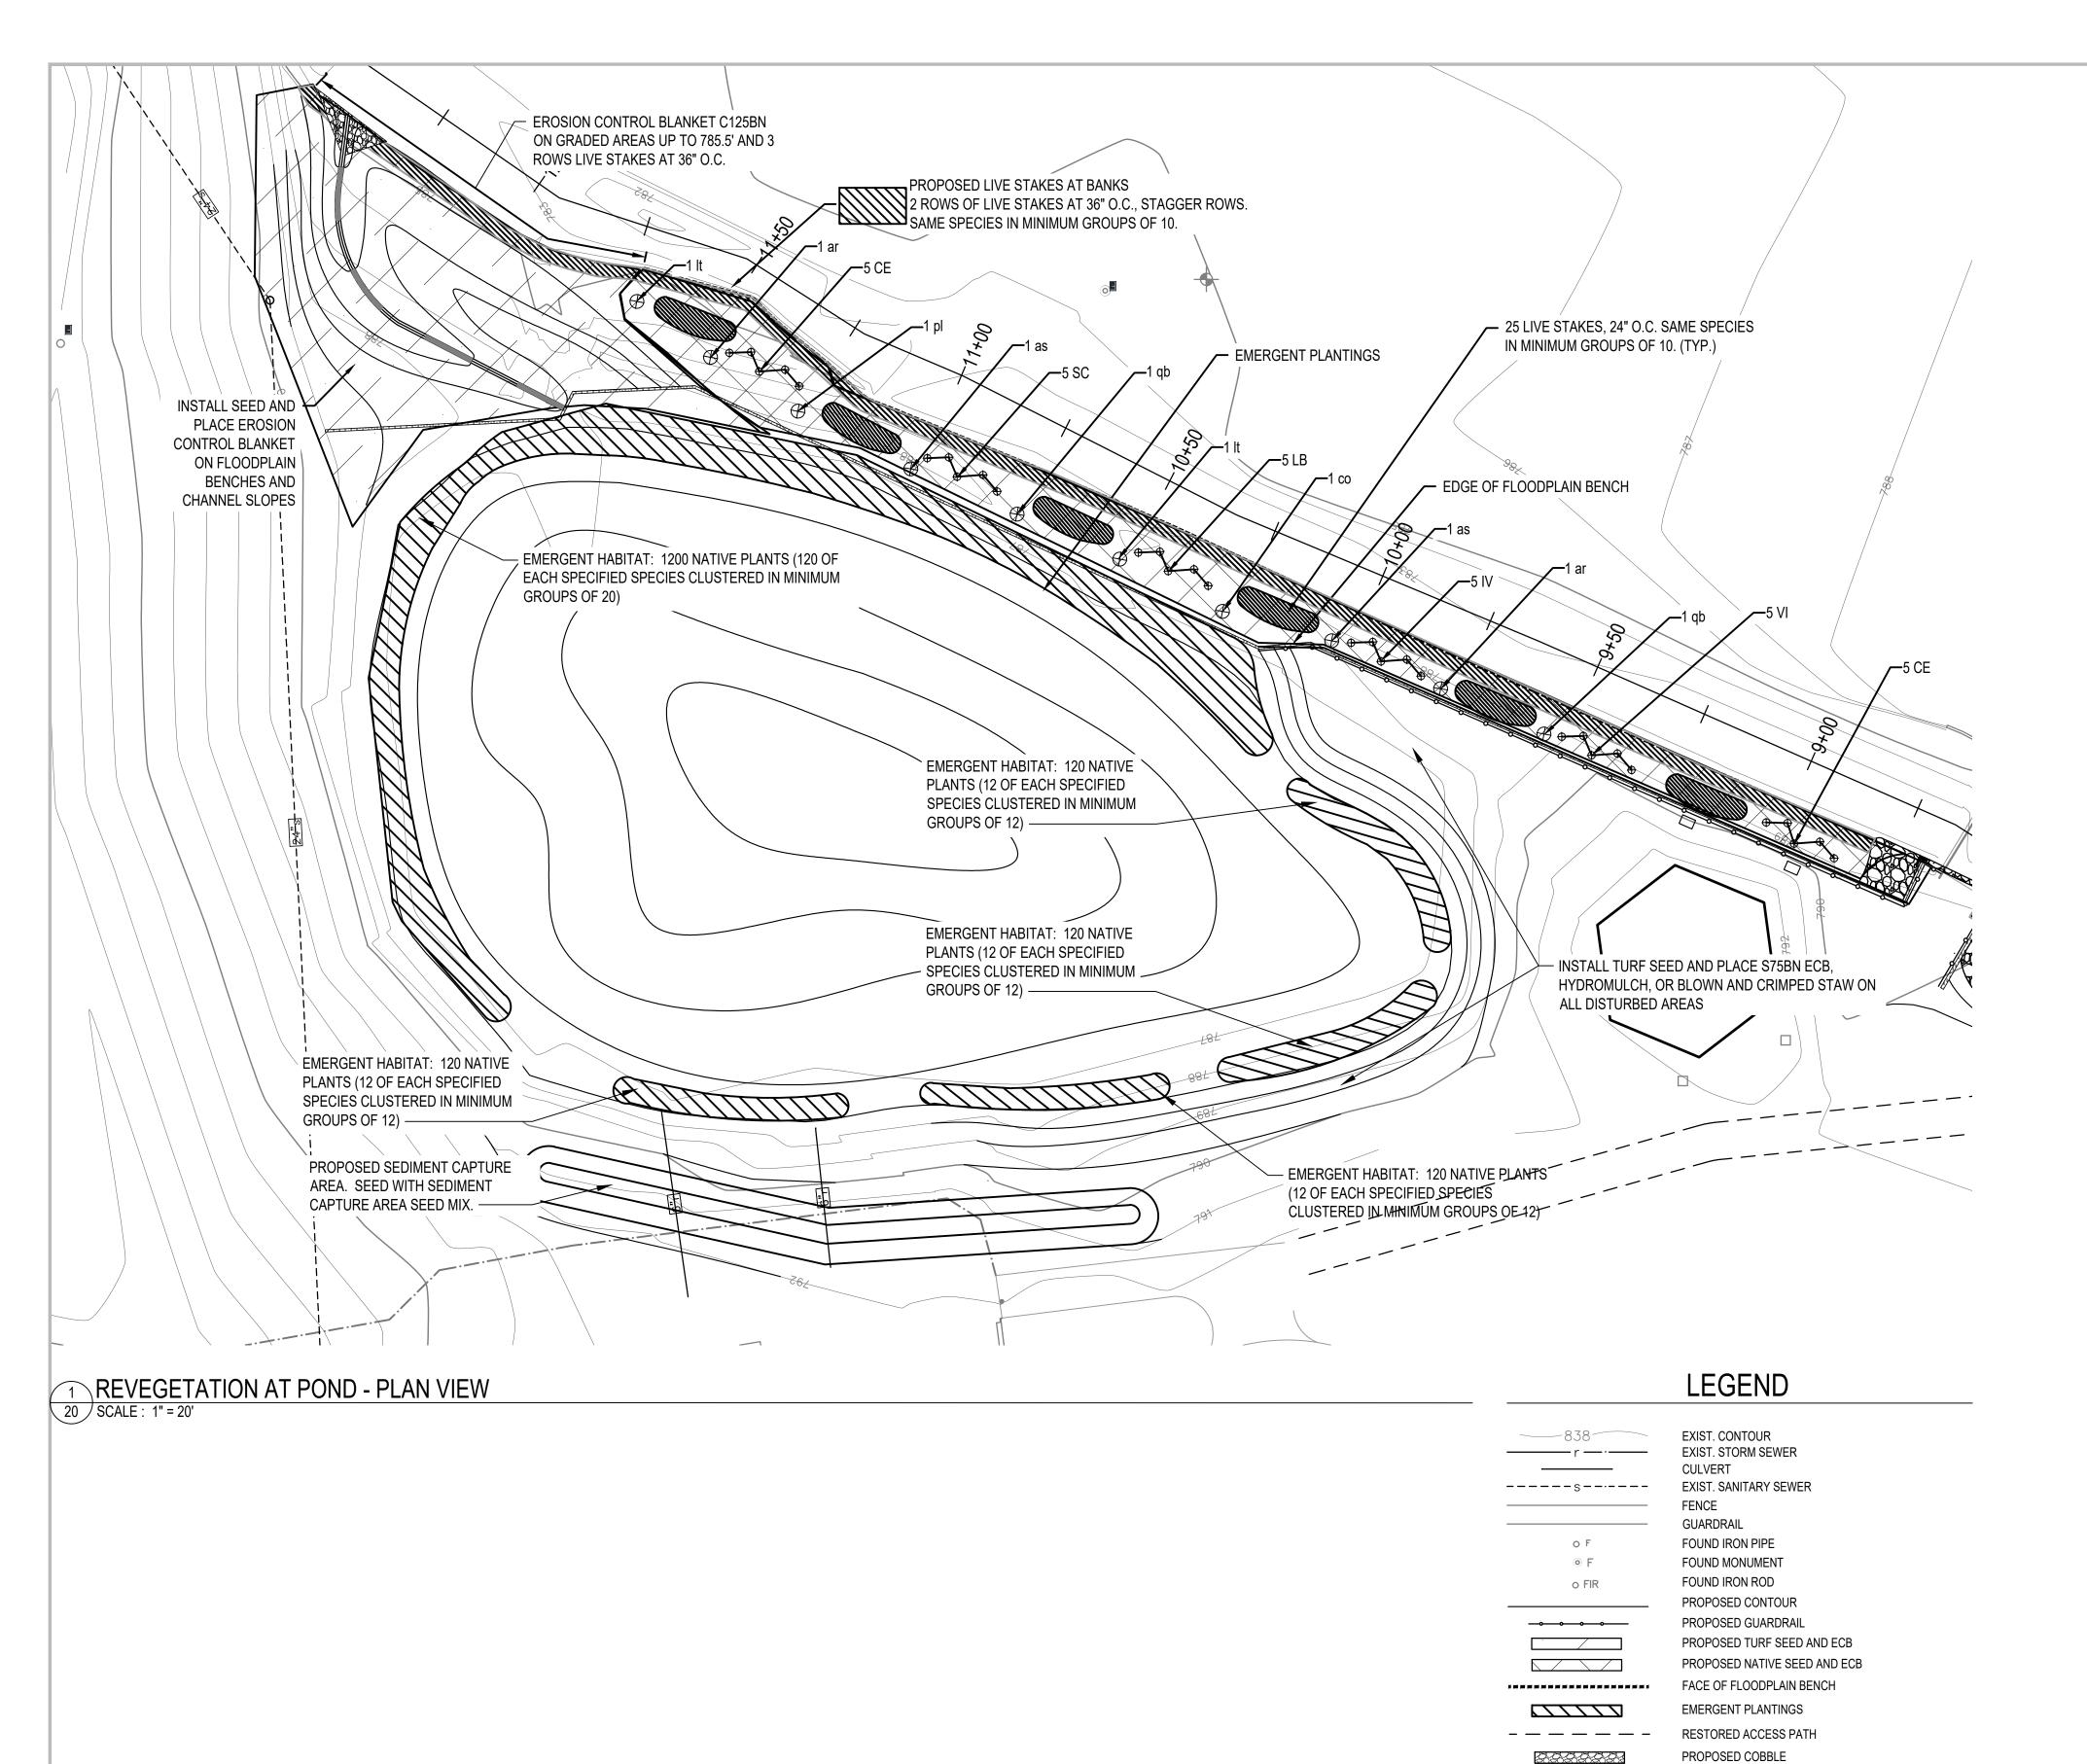
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SHEET TITLE **REVEGETATION** PLAN -

SCALE: 1" = 20' @ 22" x 34"

JOHNSON CREEK



EMERGENT PLANT LIST 168 NUPHAR ADVENA O 168 NYMPHAEA ODORATA PC 168 PONTEDERIA CORDATA PV 168 PELTANDRA VIRGINICA
SA 168 SCHOENOPLECTUS ACUTL
SL 168 SAGITTARIA LATIFOLIA C. BARE ROOT 0"- 6" BELOW WATER
C. PLUG/BARE ROOT 0"- 6" BELOW WATER
C. PLUG/BARE ROOT 0"- 6" BELOW WATER HARD-STEMMED BULRUSH COMMON ARROWHEAD BF 168 *BOLBOSCHOENUS FLUVIATILIS* RIVER BULRUSH ST 168 *SCHOENOPLECTUS TABERNAEMONTANI* GREAT BULRUSH SP 168 SPARGANIUM AMERICANUM AM. BUR REED 18" O.C. PLUG/BARE ROOT 0"- 6" BELOW WATER

TREES	\oplus				
SYM	QTY	SCIENTIFIC NAME	COMMON NAME	SIZE	CONT.
ar	2	ACER RUBRUM	RED MAPLE	N/A	1 GAL.
as	2	ACER SACCHARINUM	SILVER MAPLE	N/A	1 GAL.
CO	1	CELTIS OCCIDENTALIS	NORTHERN HACKBERRY	N/A	1 GAL.
lt	2	LIRIODENDRON TULIPIFERA	TULIP POPLAR	N/A	1 GAL.
qb	2	QUERCUS BICOLOR	SWAMP WHITE OAK	N/A	1 GAL.
pl	1	PLATANUS OCCIDENTALIS	AMERICAN SYCAMORE	N/A	1 GAL.

SHRU	BS ⊕				
SYM	QTY	SCIENTIFIC NAME	COMMON NAME	SIZE	CONT.
CE	10	CEPHALANTHUS OCCIENTALIS	BUTTONBUSH	36" HT.	3 GAL.
SC	5	SAMBUCUS CANADENSIS	AMERICAN ELDER	36" HT.	3 GAL.
LB	5	LINDERA BENZOIN	SPICEBUSH	36" HT.	3 GAL.
IV	5	ILEX VERTICILLATA	MICHIGAN HOLLY	36" HT.	3 GAL.
VI	5	VIBURNUM TRILOBUM	NANNYBERRY	36" HT.	3 GAL.

LIVE STAKE SPECIES LIST (280 TOTAL): SCIENTIFIC NAME **COMMON NAME CORNUS SERICEA** RED-OSIER DOGWOOD **SILKY DOGWOOD CORNUS AMOMUM** SALIX EXIGUA SANDBAR WILLOW SALIX DISCOLOR **PUSSY WILLOW** SALIX SERICEA **SILKY WILLOW SALIX NIGRA BLACK WILLOW** PEACH-LEAF WILLOW SALIX AMYGDALOIDES

LISTED SPECIES ARE TO BE EQUALLY REPRESENTED.

LIVE BRUSH LAYERS SPEC	IES LIST:
SCIENTIFIC NAME	COMMON NAME
CORNUS SERICEA	RED-OSIER DOGWOOD
CORNUS AMOMUM	SILKY DOGWOOD
SALIX EXIGUA	SANDBAR WILLOW
SALIX DISCOLOR	PUSSY WILLOW
SALIX SERICEA	SILKY WILLOW
SALIX NIGRA	BLACK WILLOW
SALIX AMYGDALOIDES	PEACH-LEAF WILLOW

LISTED SPECIES ARE TO BE EQUALLY REPRESENTED.

BRUSH LAYER SIZES: 5 LF (MINIMUM) PER BUNDLE, 3-4 BRANCHES THICK.

INSTALLATION NOTES: LIVE BRUSH LAYERS TO BE PLACED BETWEEN ENCAPSULATED SOIL LIFTS IN FLOODPLAIN BENCHES WITH TWO-THIRDS OF THE BASAL MATERIAL TILTED INTO THE SLOPE AND COVERED WITH SOIL. BRANCHES SHOULD PROTRUDE BEYOND THE FACE OF THE TERRACE. STARTING WITH THE FIRST SOIL LIFT ABOVE THE WATER ELEVATION AT THE TIME OF CONSTRUCTION, ADDITIONAL LIVE BRUSH LAYERS SHOULD BE ADDED BETWEEN EVERY SOIL LIFT PROCEEDING UP THE FACE OF THE STREAM BANK. PLANTING SHOULD BE DONE DURING THE DORMANT SEASON.

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ROUGE RIVER AOC JOHNSON CREEK **FISH HATCHERY PARK HABITAT RESTORATION PROJECT**


ALLIANCE OF ROUGE COMMUNITIES

NORTHVILLE, WAYNE COUNTY, **MICHIGAN**

FOR BIDDING <u>3-2020</u> 100% DESIGN DRAWINGS 2-2020 PERMIT APPLICATION <u>9-2019</u> PRE-APPLICATION MEETING <u>7-26-19</u> CLIENT MEETING <u>5-1-19</u> PRELIMINARY DESIGN <u>2-26-19</u> 180611 ECT PROJECT NUMBER

SHEET TITLE

REVEGETATION PLAN - POND

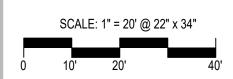

NOTES:

1. INSTALL IN MUDFLAT/TILL ZONE AS DIRECTED BY LANDSCAPE ECOLOGIST, DURING FIRST DORMANT SEASON FOLLOWING SEEDING

GROUND, AND FIRMLY PACK SOIL AROUND IT. ORIENT THE BUDS UP.

2. INSTALL LIVE STAKES AT RIGHT ANGLES PUSH INTO THE GROUND BY HAND. DEAD BLOW HAMMER AND PILOT HOLES AS NECESSARY.

4. INSTALL STAKES 3 FEET APART IN TRIANGULAR SPACING PATTERN.

3. BURY FOUR-FIFTHS OF THE STAKE IN THE

LIVE STAKE INSTALLATION 21 NO SCALE

PLANT ALL SHRUBS VERTICAL.

PRUNE ALL DEAD OR DAMAGED BRANCHES

4" BARK MULCH TO COVER ENTIRE PLANTING — HOLE. TAPER MULCH TO BASE OF PLANT.

PROVIDE 3" SOIL SAUCER AROUND EACH PLANT —

BACKFILL WITH MIX OF 50% IMPORTED TOPSOIL AND 50% EXCAVATED SITE SOIL & TAMP LIGHTLY

WATER TO SATURATE BACKFILL MATERIAL WITH IN 8 HOURS OF PLANTING

IF CONTAINER STOCK IS ROOT BOUND, MAKE 4 VERTICAL CUTS IN EACH ROOT BALL WITH SHARP BLADE

SCARIFY BOTTOM AND SIDEWALLS OF PLANTING PIT.

4 SHRUB PLANTING DETAIL NOT TO SCALE

NOTES: TREE SHALL BE PLANTED WITH TOP OF ROOT BALL AT OR SLIGHTLY ABOVE FINISH GRADE - NEVER LOWER. PRUNE ONLY AS DIRECTED EXCEPT FOR REMOVING DEAD

OR BROKEN BRANCHES;

RETAIN NATURAL FORM; DO NOT CUT LEADER. 4" MULCH TO COVER -ENTIRE PLANTING HOLE. TAPER MULCH TO TRUNK. CREATE **CONTINUOUS 6"**

EARTH SAUCER. SPECIFIED-BACKFILL SOIL

TREE IN PIT SCARIFY BOTTOM AND SIDEWALLS OF PLANTING PIT.

-REMOVE TOP 1/3

NON-BIODEGRADEABLE

OF BURLAP OR

ENTIRE RAP IF


AFTER PLACING

-6" EARTH PEDESTAL OF UNDISTURBED OR COMPACTED SOIL.

DECIDUOUS TREE PLANTING 21 NOT TO SCALE

NOTES:


- 1. SHRUB SHALL BEAR SAME OR SLIGHTLY HIGHER RELATION TO FINISH GRADE AS TO PRIOR GRADE - NEVER LOWER.
- PRUNE ONLY AS DIRECTED EXCEPT FOR REMOVING DEAD OR BROKEN BRANCHES; RETAIN NATURAL FORM.
- 3. PLANT SHRUBS WITH MAIN LEADER PERPENDICULAR TO THE GROUND SURFACE.

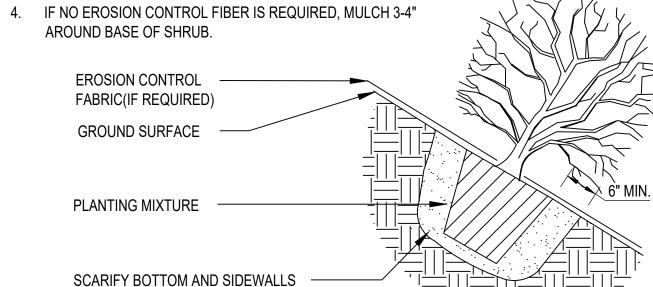

5 SLOPE SHRUB PLANTING 21 NOT TO SCALE

OF PLANTING PIT.

- 1. TREE SHALL BEAR SAME OR SLIGHTLY HIGHER RELATION TO FINISH GRADE AS TO PRIOR GRADE - NEVER LOWER.
- 2. CREATE HORIZONTAL SHELF FOR TREE WHEN PLANTING ON A SLOPE. DO NOT FILL OVER ROOT BALL ON
- PRUNE ONLY AS DIRECTED EXCEPT FOR REMOVING DEAD OR BROKEN BRANCHES; RETAIN NATURAL FORM; DO NOT CUT LEADER.
- 4. BRACE ALL DECIDUOUS TREES UP TO 4" WITH TWO STAKES.

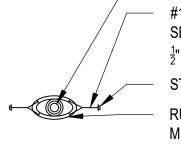


TREE TRUNK #11 GAL. WIRE SHALL BE SEMI-TAUGHT, ALLOWING FOR $\frac{1}{2}$ " MOVEMENT OF THE TREE. STEEL T-POST

RUBBER HOSE- ¹/₂" BY 12" MIN. LENGTH NEW HOSES.

#11 GALVANIZED WIRE WRAPPED ONE REVOLUTION AND BETWEEN RIDGES OF T-POST

TREE WRAP FROM BASE TO FIRST BRANCH.

3"-4" MULCH TO COVER ENTIRE PLANTING HOLE. TAPER MULCH TO TRUNK. CREATE 6" EARTH SAUCER ON SITES WITHOUT IRRIGATION.

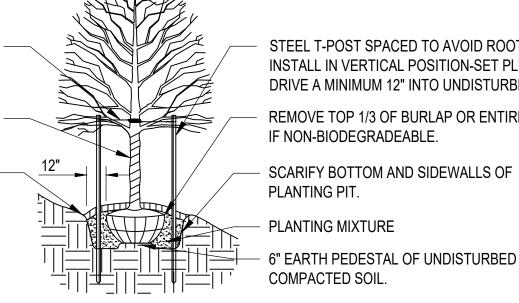


STEEL T-POST SPACED TO AVOID ROOTBALL. INSTALL IN VERTICAL POSITION-SET PLUMB. DRIVE A MINIMUM 12" INTO UNDISTURBED SOIL.

REMOVE TOP 1/3 OF BURLAP OR ENTIRE RAP IF NON-BIODEGRADEABLE.

PLANTING PIT.

PLANTING MIXTURE 6" EARTH PEDESTAL OF UNDISTURBED OR COMPACTED SOIL.

3 SLOPE TREE PLANTING 21 NOT TO SCALE

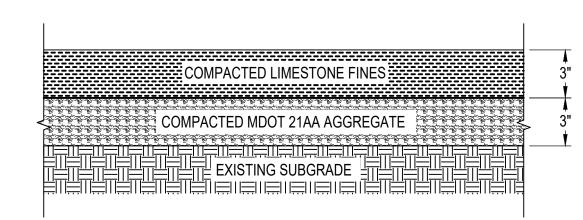

GRAVEL ACCESS PATH

21 NOT TO SCALE

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ROUGE RIVER AOC JOHNSON CREEK FISH HATCHERY PARK HABITAT RESTORATION

ALLIANCE OF ROUGE COMMUNITIES

PROJECT

NORTHVILLE, WAYNE COUNTY, **MICHIGAN**

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PRELIMINARY DESIGN 180611 ECT PROJECT NUMBER

SRD JOM
DRAWN BY APPROVED BY

SHEET TITLE

DETAILS -**REVEGETATION**


SCALE: VARIES


JOB BENCHMARK #200 FOUND RR SPIKE IN S SIDE OF WOOD LT POLE S OF FAIRBROOK ST 25' NE OF PARK SIGN, 45' NW OF FP JOB BENCHMARK #201 SET SPINDLE IN S SIDE OF WOOD

LP S SIDE OF FAIRBROOK ST 60'
N OF W END OF GRAVEL LOT ARCHITECTS ENGINEERS PLANNERS JOB BENCHMARK #202 SET SPINDLE IN W SIDE OF 24" TREE


18' E OF GRAVEL LOT 60' N OF S

EDGE OF GRAVEL LOT 34000 Plymouth Road #325 SANITARY MANHOLE T/CAST 805.20 BOLTED ON Livonia, MI 48150 P (734) 522-6711 | F (734) 522-6427 #463 SANITARY MANHOLE T/CAST 801.74 24" CLAY INV E 779.84 24" CLAY INV SW 779.84 FLOWS EAST JOB BENCHMARK #203 SET "T" ON CONCRETE WALL, E SIDE SIGN REGULATORY(2) OHM-ADVISORS.COM OF POND 135' N OF CONC BRIDGE ELEV 788.23 #485 STORM MANHOLE T/CAST 798.75 6" INV N 793.25 12" INV N 792.65 12" CONC INV S 790.85 TRAVERSE POINT #100 N 338120.00 E 13359131.26 ELEV 804.31 48-005-99-0006-000 CITY OF NORTHVILLE 215 W MAIN ST. NORTHVILLE, MI-48167 #504 SANITARY MANHOLE T/CAST 797.67 24" CLAY INV S 781.17 24" CLAY INV E 780.97 TRAVERSE POINT #101 N 337904.89 E 13358971.75 ELEV 794.65 #531 YARD DRAIN T/CAST 792.72 8" CLAY INV W 788.62 TRAVERSE POINT #102 N 337948.53 #538 STORM MANHOLE T/CAST 794.59 8" CLAY INV NW 786.79 E 13359249.58 ELEV 791.37 SIGN_REGULATORY TRAVERSE POINT #103 N 337887.02 E 13359387.70 ELEV 787.89 SIGN REGULATOR LANDSCAPING - ŞIGN BILLBOARD SIGN REGULATORY IRRIGATION CONTROL VALVE -1 EDGE OF WATER GUY WIRE AMCHOR, (TYP) 6" CMP INV W - MASONRY WALL 6" CLAY INV W 77-033-99-0001-000 CITY OF NORTHVILLE 215 W MAIN ST. NORTHVILLE, MI 48167 REHABILITATE APPROX. 315 FEET OF EXISTING POURED CONCRETE RETAINING WALL - DESIGN CURRENTLY IN PROGRESS BY SME SIGN REGULATORY(2) SIGN REGULATORY -__ SIGN REGULATORY SIGN REGULATORY 48-005-99-0002-000 77-033-99-0002-000 NORTHVILLE PARKS & RECREATION FISH HATCHERY PARK - SITE PLAN Know what's below.
Call before you dig. OF 1

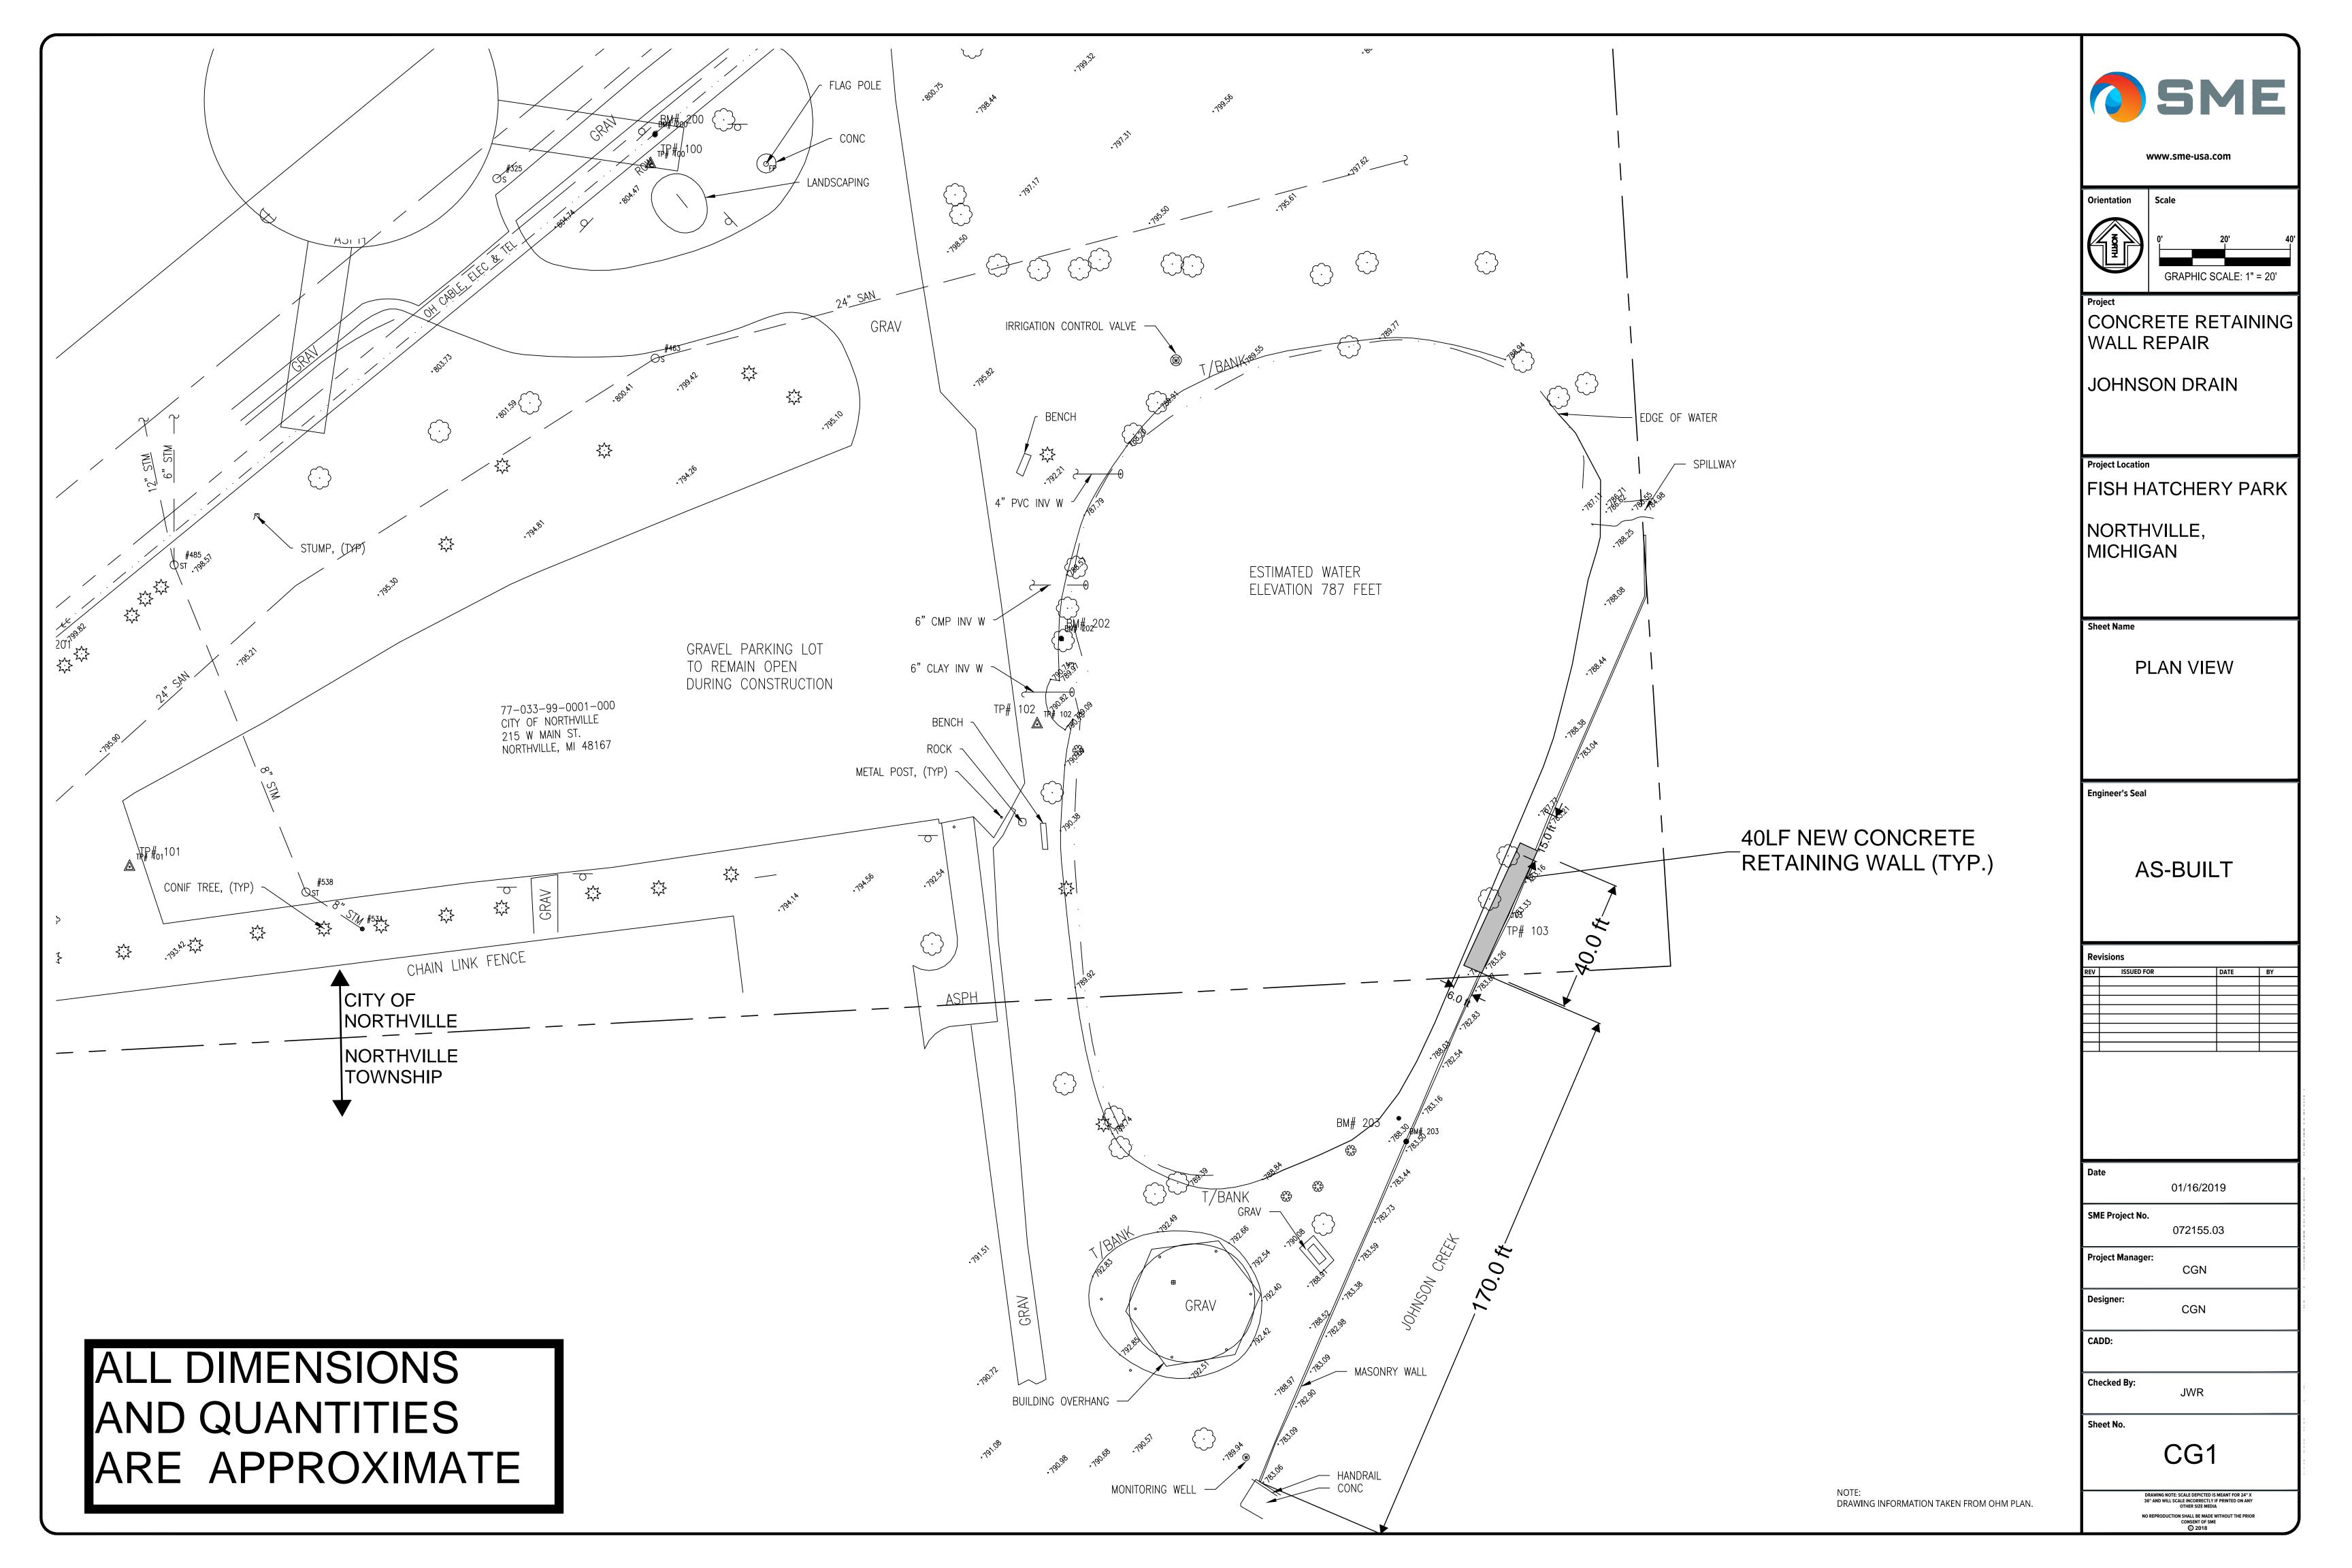


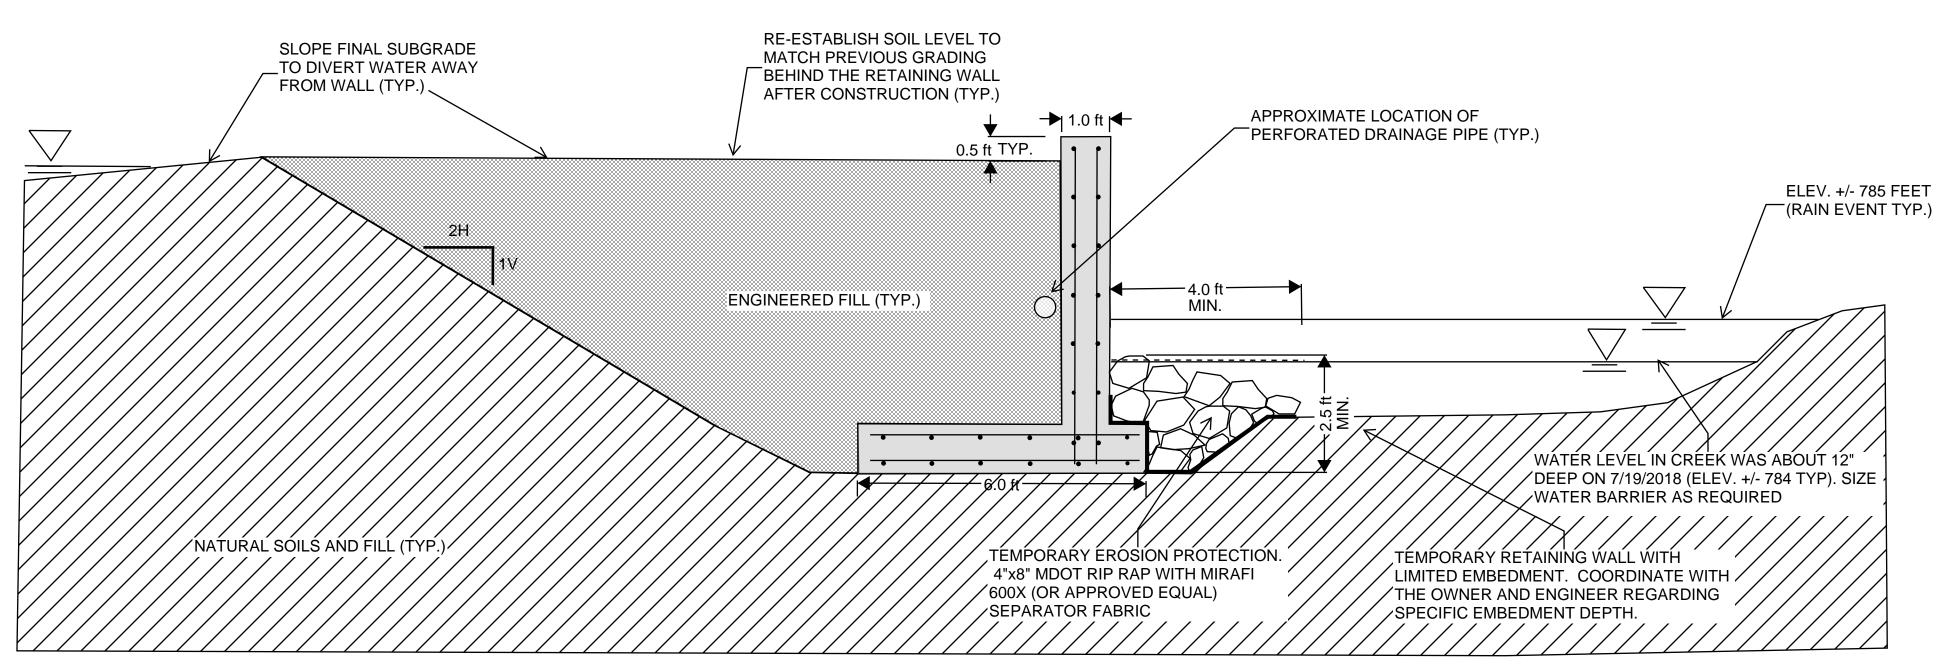

SECTION 1: NEW WALL - AFTER CONSTRUCTION

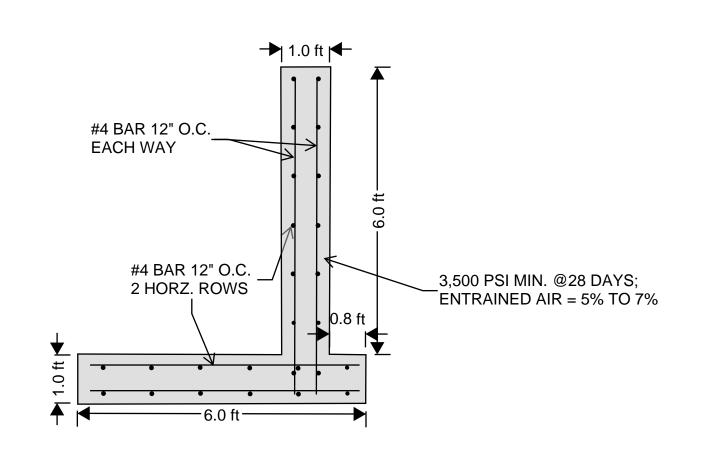

DETAIL 1: PROPOSED WALL STEEL REINFORCEMENT

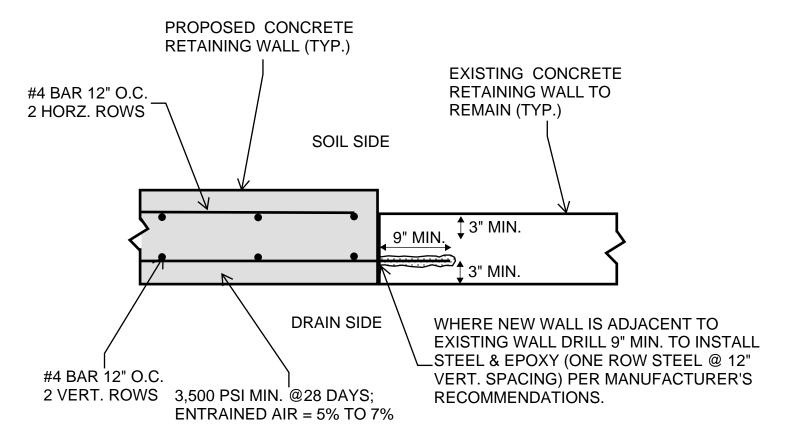

DETAIL 2: PROPOSED WALL AND EXISTING WALL CONNECTION

ALL DIMENSIONS
AND QUANTITIES
ARE APPROXIMATE

SME
www.sme-usa.com

Orientation Scale NTS

CONCRETE RETAINING
WALL REPAIR

JOHNSON DRAIN

Project Location

FISH HATCHERY PARK

NORTHVILLE, MICHIGAN

Sheet Nam

SECTIONS AND DETAILS

Engineer's Seal

AS-BUILT

Re	Revisions					
REV	ISSUED FOR	DATE	BY			

Date 01/16/2019

SME Project No.

072155.03

CGN

Project Manager:

Designer:


CADD:

Checked By:

Sheet No.

CG1.01

DRAWING NOTE: SCALE DEPICTED IS MEANT FOR 24" X
36" AND WILL SCALE INCORRECTLY IF PRINTED ON ANY
OTHER SIZE MEDIA
NO REPRODUCTION SHALL BE MADE WITHOUT THE PRIOR
CONSENT OF SME

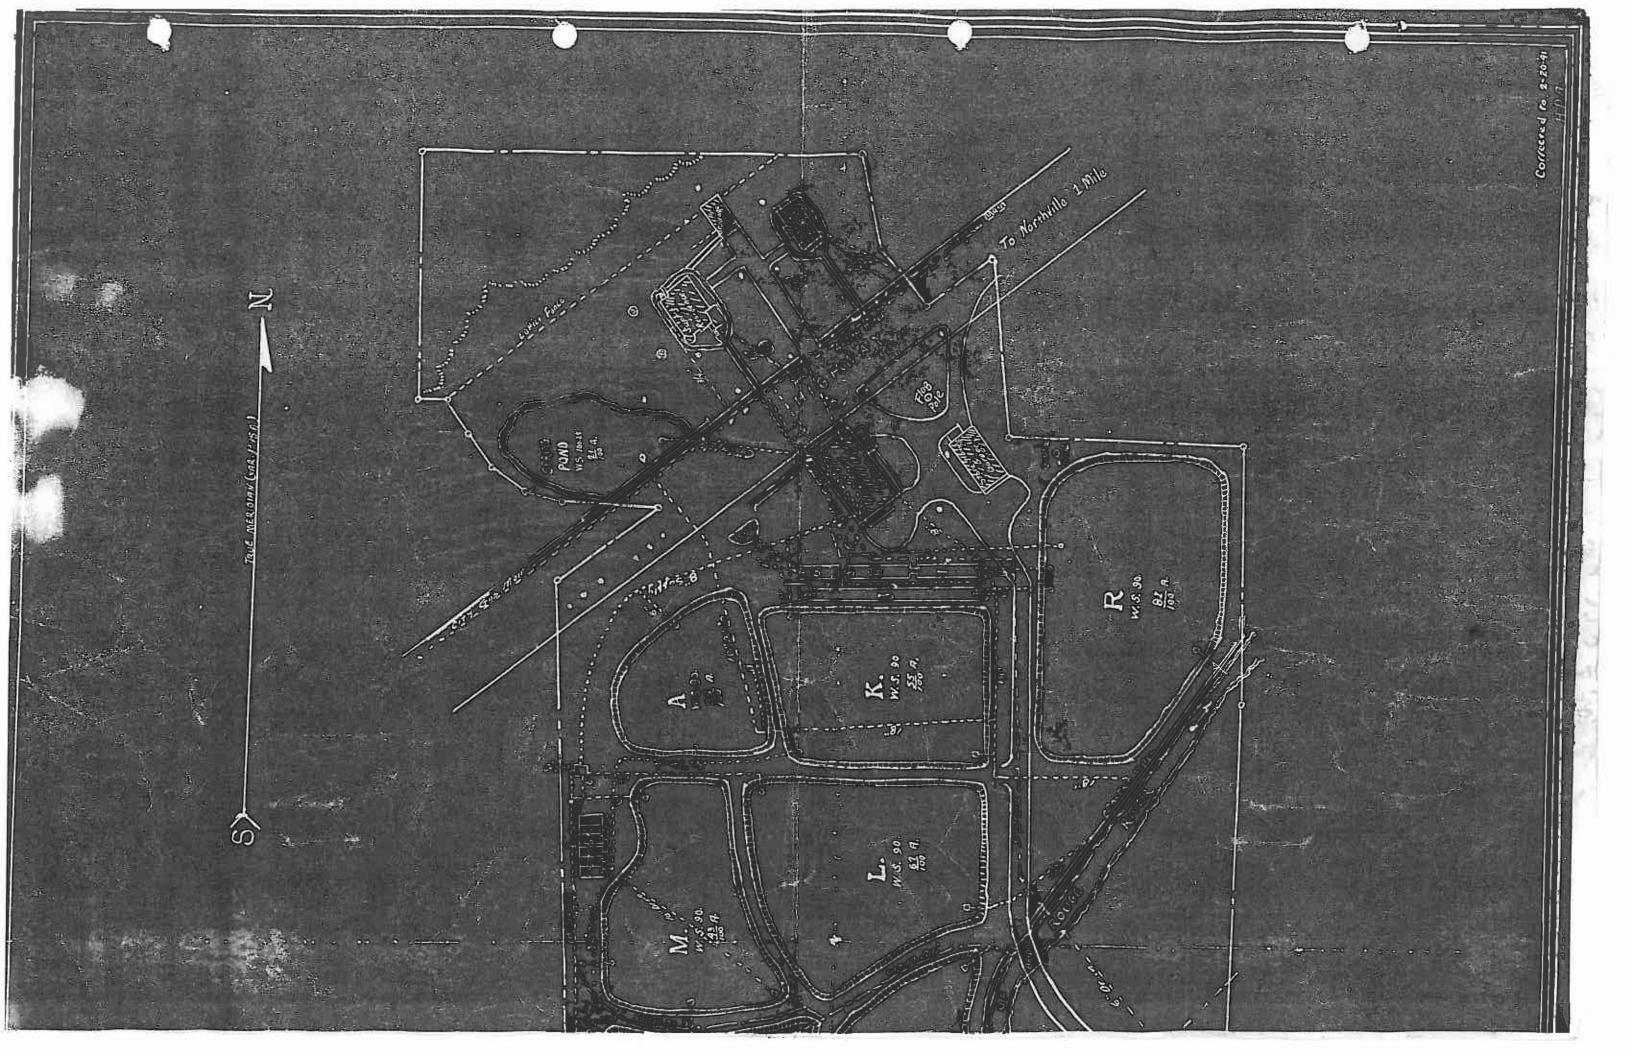

DEPARTMENTOR INTERIOR FISH AND WILDLIFE SERVICE

NORTHVILLE STATION MICHIGAN. 1941

